
- CONSTRUCTION AND THE 1992 STANDARD DETAILS AND SUBSEQUENT ADDENDA FOR PUBLIC WORKS CONSTRUCTION AS ADOPTED BY THE CITY COUNCIL. A DIGITAL COPY OF THE SPECIFICATIONS AND DETAILS IS AVAILABLE AT: HTTP://WWW.SANJOSECA.GOV/INDEX.ASPX?NID=2247


- REQUIRED IN SECTION 21-1.05 OF THE STANDARD SPECIFICATIONS. COMPACT SUBGRADE FOR CURB, GUTTER AND

- THE 1988 CALTRANS STANDARD SPECIFICATIONS. THE ASPHALTIC EMULSION USED SHALL BE SS-1H.
- PRIME COAT ALL AGGREGATE BASE SURFACES PRIOR TO PLACING A.C. PAVING UNLESS THE TOTAL THICKNESS OF A.C.
- REQUIRED FOR FULL DEPTH AC ALTERNATE.
- ALL IRRIGATION LINES OR OTHER PRIVATELY OWNED UNDERGROUND LINES THAT REQUIRE RELOCATION AS DETERMINED BY
- CONSTRUCTION PURPOSES IS PROHIBITED. RECYCLED WATER IS AVAILABLE AT MULTIPLE LOCATIONS ACROSS THE CITY MORE INFORMATION, PLEASE CALL LYLE FROHMAN AT (408) 794-6805.
- - ORDINARILY ENCOUNTERED AND GENERALLY RECOGNIZED AS INHERENT IN WORK OF THE CHARACTER PROVIDED FOR IN NECESSARY, INITIATE FURTHER ANALYSIS OF THE PROBLEM. IF REMEDIATION IS REQUIRED, A REMEDIATION PLAN WILL BE SUBMITTED TO THE DIRECTOR OF PUBLIC WORKS FOR REVIEW BY ENVIRONMENTAL MANAGEMENT AND, UPON APPROVAL BY THE DIRECTOR, BE IMPLEMENTED AT DEVELOPER'S SOLE EXPENSE.
- IN THE EVENT THAT HUMAN REMAINS AND/OR CULTURAL MATERIALS ARE FOUND, ALL PROJECT-RELATED CONSTRUCTION SHOULD CEASE WITHIN A 100-FOOT RADIUS. THE CONTRACTOR SHALL, PURSUANT TO SECTION 7050.5 OF THE HEALTH AND SAFETY CODE, AND SECTION 5097.94 OF THE PUBLIC RESOURCES CODE OF THE STATE OF CALIFORNIA, NOTIFY THE SANTA CLARA COUNTY CORONER IMMEDIATELY.
- CONTRACTOR SHALL PROVIDE VIDEO INSPECTION OF ALL STORM AND SANITARY SEWER MAINS. VIDEO INSPECTION OF ALL MAINS SHALL BE PERFORMED AFTER ALL TESTING HAS BEEN COMPLETED.
- CONTRACTOR SHALL REMOVE ALL U.S.A MARKINGS AS SOON AS THEY ARE NO LONGER NEEDED. ONLY CHALK PAINT SHALL BE USED IN THE REDEVELOPMENT AREA (BOUNDED BY JULIAN STREET AND HIGHWAY 280, AND BETWEEN HIGHWAY 87 AND FOURTH STREET). REMOVAL OF PAINT SHALL BE BY HIGH WATER PRESSURE METHOD ONLY.
- 15. INSTALLATION OR REMOVAL OF STREET TREES REQUIRES A PERMIT FROM THE DEPARTMENT OF TRANSPORTATION. THE CITY ARBORIST WILL SPECIFY SPECIES. CONTACT THE CITY ARBORIST BY EMAIL AT DEVELOPMENTPROJECT@SANJOSECA.GOV WITH YOUR PROJECT INFORMATION TO OBTAIN A TREE PERMIT.
- IF CONTRACTOR DAMAGES EXISTING ASPHALT SECTION DURING THE REMOVAL OF EXISTING CURB AND GUTTER OR AT THE DISCRETION OF THE PROJECT INSPECTOR, THE ASPHALT CONCRETE SHALL BE REPAIRED BY SAWCUTTING 12" MINIMUM FROM THE LIP OF GUTTER AND INSTALLING A 12" MINIMUM 'DEEP-LIFT' AC SECTION.
- CITY SURVEY MONUMENTS SHALL BE PRESERVED. IN THE EVENT THAT A CITY MONUMENT IS LOST TO CONSTRUCTION ACTIVITIES, THE CONTRACTOR SHALL, AT THE CONTRACTOR'S SOLE EXPENSE, BE RESPONSIBLE FOR ITS RE-ESTABLISHMENT AND THE FILING OF A CORNER RECORD WITH THE COUNTY'S SURVEYOR'S OFFICE. A RECORD OF SURVEY SHALL BE FILED FOR ALL NEW CITY MONUMENTS SET IN CONJUNCTION WITH THIS IMPROVEMENT PLAN, UNLESS A FINAL OR PARCEL MAP REQUIRING SAID MONUMENTS IS RECORDED AS PART OF THIS PROJECT.
- PAVEMENT MARKING AND STRIPING LAYOUT AND TRAFFIC SIGNAL LOOP LAYOUT SERVICES SHALL BE PROVIDED BY THE DEVELOPER'S ENGINEER, SURVEYOR, OR OTHER QUALIFIED PERSONNEL.
- PLAN REFERENCES (I.E. PLANNING PERMIT NUMBER, RECORD DRAWINGS, ETC.)

# PUBLIC ENCROACHMENT PERMIT FOR THE DOWNTOWN WEST UTILIDOR ON

SAN CARLOS ST, S. MONTGOMERY ST, PARK AVE, W. SAN FERNANDO ST, VTA LIGHT RAIL, CRANDALL ST, CAHILL ST, W. JULIAN ST, RAILROAD CROSSING, AND CINNABAR ST SAN JOSE, CALIFORNIA

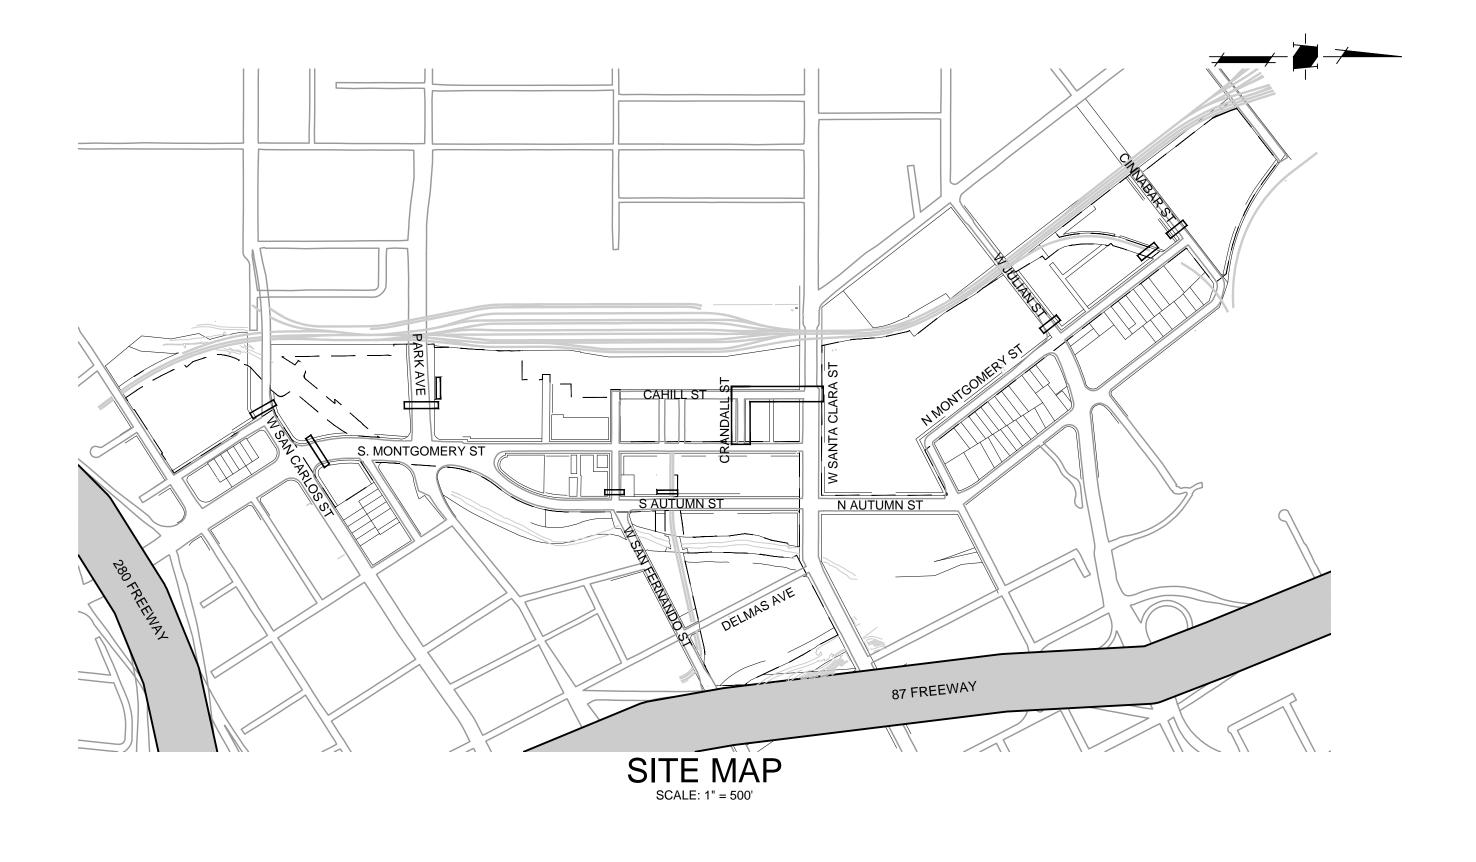

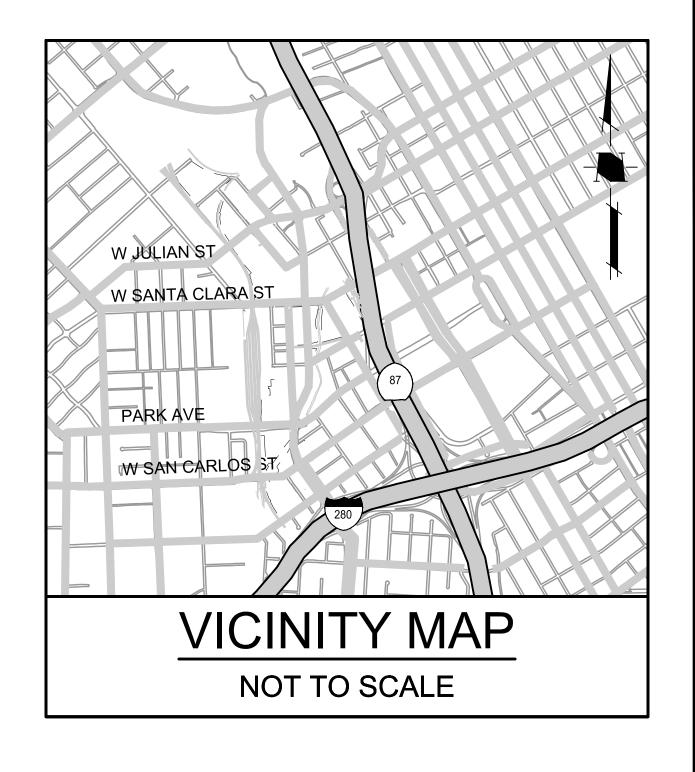

#### **ENGINEER'S STATEMENT**

THESE IMPROVEMENT PLANS HAVE BEEN PREPARED BY ME OR UNDER MY DIRECTION IN ACCORDANCE WITH STANDARD ENGINEERING PRACTICE.

SAN JOSE

1570 Oakland Road

San Jose, CA 95131





PUBLIC ENCROACHMENT PERMIT FOR THE

DOWNTOWN WEST UTILIDOR

THE CALCULATED BEARING OF SOUTH 02° 43' 35" WEST TAKEN BETWEEN THE RECORD POSTION OF GPS CONTROL POINT 2218 AND GPS CONTROL POINT 1049, AS SHOWN ON THAT CERTAIN RECORD OF SURVEY FILED FOR RECORD ON JUNE 21, 1996, IN BOOK 677 OF MAPS AT PAGE 54, OFFICIAL RECORDS OF SANTA CLARA COUNTY WAS TAKEN AS THE BASIS FOR ALL BEARINGS SHOWN HEREON.

PROJECT BASIS OF BEARING

#### PROJECT BENCHMARK

ELEV DATUM: SCVWD BM365=83.71', NAVD88, DATE ADJUSTED MARCH 14, 2017 VALLEY TRANSPORTATION AGENCY'S ALUMINUM DISK (VTA-225); ON TOP AND AT MID CONCRETE SIDEWALK, 3.1 FEET SOUTH FROM FACE OF CURB, 12 FEET WEST FROM THE SOUTHEAST CORNER OF NEW JULIAN STREET BRIDGE OVER GUADALUPE RIVER BETWEEN HIGHWAY 87 AND AUTUMN STREET, CITY OF SAN JOSE.

### SHEET INDEX

SHEET NO.

UNAUTHORIZED CHANGES & USES: THE ENGINEER PREPARING THESE PLANS WILL NOT BE RESPONSIBLE FOR, OR LIABLE FOR, UNAUTHORIZED CHANGES TO

OR USES OF THESE PLANS. ALL CHANGES TO THE PLANS MUST BE IN WRITING

AND MUST BE APPROVED BY THE PREPARER OF THESE PLANS.

COVER SHEET NOTES, LEGEND, AND ABBREVIATIONS DETAILS PLAN AND PROFILE - WEST SAN CARLOS STREET PLAN AND PROFILE - SOUTH MONTGOMERY STREET PLAN AND PROFILE - PARK AVENUE PLAN AND PROFILE - PARK AVENUE PLAN AND PROFILE - WEST SAN FERNANDO STREET PLAN AND PROFILE - VTA LIGHT RAIL CROSSING PLAN AND PROFILE - CRANDALL STREET PLAN AND PROFILE - CAHILL STREET PLAN AND PROFILE - CAHILL STREET SECTIONS PLAN AND PROFILE - WEST JULIAN STREET PLAN AND PROFILE - RAILROAD CROSSING PLAN AND PROFILE - CINNABAR STREET PLAN AND PROFILE - SAN FERNANDO CREEK CROSSING PLAN AND PROFILE - SAN FERNANDO CREEK CROSSING PLAN AND PROFILE - CREEK CROSSING

> **PRELIMINARY** NOT FOR CONSTRUCTION

DEPARTMENT OF PUBLIC WORKS PERMIT # INSPECTOR: PROJECT# VOICEMAIL: DEPARTMENT OF TRANSPORTATION MUNICIPAL WATER CAPITAL OF SILICON VALLEY TREETLIGHT LAYOUT APPROVED BY MATTHEW CANO DIRECTOR OF PUBLIC WORKS ELECTRICAL CIRCUITS

HMHca.com

**1ST SUBMITTAL** 

CALIFORNIA

LA/RM/JBC/DK

VNM

5719.00

MARCH 1, 2021

DRAWN BY:

**DESIGNED BY** 

CHECKED BY

- 1. REVISIONS TO THESE PLANS MUST BE REVIEWED AND APPROVED IN WRITING BY HMH AND THE CITY OF SAN JOSE PRIOR TO CONSTRUCTION OF AFFECTED ITEMS.
- 2. THE CONTRACTOR SHALL NOTIFY HMH, AT (408) 487-2200 BEFORE PROCEEDING WITH ANY WORK THAT APPEARS TO BE INSUFFICIENTLY DETAILED.
- 3. CONTRACTOR SHALL REPLACE OR REPAIR, AT CONTRACTOR'S EXPENSE, ALL DAMAGED, REMOVED OR
- OTHERWISE DISTURBED EXISTING UTILITIES, OR IMPROVEMENTS IN KIND.
- 4. CONTRACTOR SHALL COORDINATE WORK WITH SUBCONTRACTORS. ONGOING GRADING OR SITE WORK OF OTHER CONTRACTORS, AND WITH THE INSTALLATION OF FACILITIES BY PG&E, AT&T AND CABLE TV.
- 5. IF TEMPORARY LANE CLOSURES ARE REQUIRED FOR CONSTRUCTION OPERATIONS, THE CONTRACTOR SHALL PREPARE A TRAFFIC CONTROL PLAN AND OBTAIN APPROVAL FROM THE CITY OF SAN JOSE BEFORE COMMENCING WORK. THE CONTRACTOR SHALL ALSO PROVIDE FLAG MEN, CONES OR BARRICADES, AS NECESSARY TO CONTROL TRAFFIC AND PREVENT HAZARDOUS CONDITIONS, PER CALTRANS STANDARDS.
- 6. EXISTING PEDESTRIAN WALKWAYS, BIKE PATHS AND DISABLED ACCESS PATHWAYS SHALL BE MAINTAINED DURING CONSTRUCTION TO THE SATISFACTION OF THE CITY INSPECTOR.
- 7. CONTRACTOR SHALL BACKFILL TRENCHES, OR PLACE STEEL PLATING AND/OR HOT-MIX ASPHALT, AS REQUIRED BY THE CITY INSPECTOR, TO PROTECT OPEN TRENCHES AT THE END OF EVERY WORK DAY.
- 8. CONTRACTOR SHALL CLEAN STREETS TO REMOVE ACCUMULATION OF MUD AND DEBRIS RESULTING FROM CONSTRUCTION ACTIVITIES.
- 9. THE CONTRACTOR IS RESPONSIBLE FOR CONFORMING TO EXISTING PAVEMENT, ADJACENT LANDSCAPE AND OTHER IMPROVEMENTS WITH A SMOOTH TRANSITION IN PAVING, CURBS, GUTTERS, SIDEWALK, ETC. TO AVOID ABRUPT OR APPARENT CHANGES IN GRADES OR CROSS SLOPES, LOW SPOTS OR HAZARDOUS CONDITIONS.
- 10. CONTRACTOR TO OBTAIN REQUIRED PERMITS FOR HAUL ROUTES PRIOR TO DEMOLITION AND CONSTRUCTION.
- 11. CONTRACTOR IS RESPONSIBLE FOR SCHEDULING ALL INSPECTIONS AS REQUIRED.
- 12. CONTRACTOR IS TO PROVIDE STREET CROSS SLOPES BETWEEN 2% AND 4% UNLESS SPECIFICALLY NOTED OTHERWISE ON PLANS, AND TO ALLOW CITY INSPECTOR AND ENGINEER TO INSPECT FORMS PRIOR TO POURING OF CURB AND GUTTER.
- 13. CONTRACTOR IS TO POTHOLE ALL UTILITY CONNECTIONS PRIOR TO CONSTRUCTION TO VERIFY INFORMATION PROVIDED ON PLAN REGARDING EXISTING UTILITIES.
- 14. IT IS THE CONTRACTOR'S RESPONSIBILITY TO VERIFY THE LOCATIONS OF ALL EXISTING UNDERGROUND UTILITIES. CALL USA (UNDERGROUND SERVICE ALERT) TWO WORKING DAYS BEFORE DIGGING AT (811). LOCATIONS SHOWN ON THE PLANS WERE TAKEN FROM AVAILABLE RECORDS AND ARE APPROXIMATE AND SHOWN FOR GENERAL INFORMATION ONLY, AND MAY BE INCOMPLETE. RELOCATION OR REPAIR OF ANY DAMAGE TO UTILITIES OR PIPELINES AND PLUGGING OR REMOVAL OF ABANDONED LINES SHALL BE THE CONTRACTOR'S RESPONSIBILITY.
- 15. THE LOCATION OF THE MONUMENTS SHOWN ON THIS PLAN ARE FOR GENERAL INFORMATION ONLY. REFER TO THE FINAL MAP FOR THE LOCATION OF EXISTING AND PROPOSED MONUMENTS.
- 16. IT IS THE CONTRACTOR'S RESPONSIBILITY TO MAINTAIN AND PRESERVE THE EXISTING MONUMENTS OF RECORD. SHOULD THE CONTRACTOR DESTROY OR DISTURB ANY MONUMENTS OF RECORD. THE CONTRACTOR SHALL, AT CONTRACTOR'S SOLE EXPENSE, RETAIN A CALIFORNIA LICENSED LAND SURVEYOR TO REPLACE SAID MONUMENTS AND FILE AN APPROPRIATE CORNER RECORD.
- 17. CONTRACTOR SHALL KEEP UP-TO-DATE A COMPLETE RECORD SET OF CONTRACT DRAWINGS SHOWING EVERY CHANGE FROM THE ORIGINAL DRAWINGS MADE DURING THE COURSE OF CONSTRUCTION INCLUDING EXACT LOCATION, SIZES, MATERIALS AND EQUIPMENT. A COMPLETE SET OF CORRECTED AND COMPLETED RECORD DRAWING PRINTS SHALL BE SUBMITTED TO THE ENGINEER PRIOR TO FINAL ACCEPTANCE FOR REVIEW AND APPROVAL BY THE ENGINEER.
- 18. EXTENT OF PAVEMENT SAW CUTTING MAY REQUIRE FIELD ADJUSTMENT DUE TO THE UNEVEN NATURE OF EXISTING PAVEMENTS AND INTERMITTENT NATURE OF DATA COLLECTED FOR DESIGN PURPOSES. CONTACT ENGINEER IF FIELD CONDITIONS DIFFER FROM THOSE ANTICIPATED ON PLAN.

#### **EXISTING CONDITIONS**

- 1. EXISTING GRADES AND CONFORM DESIGNS SHOWN ARE BASED OFF OF INTERMITTENT FIELD TOPO DATA AND MAY NOT INCLUDE ALL CONFORM SITUATIONS. CONTRACTOR SHALL REVIEW ALL CONFORM CONDITIONS AND NOTIFY ENGINEER OF ANY AREAS THAT MAY REQUIRE FIELD FIT ADJUSTMENTS. ALL PAVING AND HARDSCAPE CONFORMS MUST COMPLY WITH ADA REQUIREMENTS AND MAINTAIN POSITIVE DRAINAGE TO DRAIN INLETS.
- 2. GRADES ENCOUNTERED ON-SITE MAY VARY FROM THOSE SHOWN. CONTRACTOR SHALL REVIEW THE PLANS AND CONDUCT INVESTIGATIONS AS REQUIRED TO VERIFY EXISTING CONDITIONS AT THE PROJECT SITE.
- 3. INFORMATION REGARDING EXISTING UTILITIES IS FROM RECORD DATA AND MAY NOT REPRESENT ACTUAL CONDITIONS. CONTRACTOR SHALL CONDUCT FIELD EVALUATION OF ALL EXISTING SUBSURFACE IMPROVEMENTS AND UTILITIES, WHETHER SHOWN ON THESE PLANS OR NOT, PRIOR TO THE COMMENCEMENT OF WORK. CONTRACTOR SHALL CONTACT HMH IF ANY DISCREPANCIES ARE

#### UTILITIES

- 1. UTILITY BOXES AND LIDS IN PAVED AREAS SHALL BE DESIGNED FOR H-20 LOADING.
- 2. MANHOLES THAT ARE LOCATED IN UNPAVED AREAS SHALL HAVE BOLT DOWN COVERS.
- 3. CONTRACTOR TO COORDINATE THE ADJUSTMENT TO FINISH GRADE OF ALL PG&E, AT&T, CABLE, FIBER OPTIC OR OTHER UTILITY MANHOLES AND VAULTS.
- 4. CONSTRUCTION OF ALL GRAVITY FLOWING UTILITIES SHALL PROCEED FROM THE DOWNSTREAM CONNECTION TO THE UPSTREAM CONNECTION. THIS WILL ALLOW FOR ANY NECESSARY ADJUSTMENTS TO BE MADE PRIOR TO THE INSTALLATION OF THE ENTIRE LINE. IF THE CONTRACTOR FAILS TO BEGIN AT THE DOWNSTREAM CONNECTION POINT AND WORK UPSTREAM, CONTRACTOR SHALL PROCEED AT CONTRACTOR'S OWN RISK AND BE RESPONSIBLE FOR ANY ADJUSTMENTS NECESSARY.
- 5. PROPOSED WATER SYSTEM SHOWN ON CIVIL PLANS IS GRAPHICAL AND FOR COORDINATION PURPOSES ONLY. SEE PLANS BY OTHERS.
- 6. PROPOSED ELECTRIC, GAS, TELEPHONE, CABLE AND JOINT TRENCH INFORMATION SHOWN ON CIVIL PLANS IS GRAPHICAL AND FOR COORDINATION PURPOSES ONLY. SEE JOINT TRENCH PLANS.

#### STATEMENT OF RESPONSIBILITY

CONTRACTOR SHALL ASSUME SOLE AND COMPLETE RESPONSIBILITY FOR JOB SITE CONDITIONS DURING THE COURSE OF CONSTRUCTION OF THIS PROJECT, INCLUDING SAFETY OF ALL PERSONS AND PROPERTY. THIS REQUIREMENT SHALL APPLY CONTINUOUSLY AND NOT BE LIMITED TO NORMAL WORKING HOURS. THE CONTRACTOR SHALL DEFEND, INDEMNIFY AND HOLD THE OWNER AND THE ENGINEER HARMLESS FROM ANY AND ALL LIABILITY, REAL OR ALLEGED, IN CONNECTION WITH THE PERFORMANCE OR WORK ON THIS PROJECT, EXCEPTING FOR LIABILITY ARISING FROM THE SOLE NEGLIGENCE OF THE OWNER OR THE ENGINEER.

DATE:	MARCH 1, 2021
SCALE:	NTS
DESIGNED:	RH
DRAWN:	LA/RM/JBC/DK
CHECKED:	VNM
PROJ. ENGR:	VNM
FILE:	571900IP.DWG

agOFESS/Q	
N. M. M. M. C. C. C.	PRELIMINARY
No. 73073 → Min 7	NOT FOR CONSTRUCT
OF CALLED	

PLAN
FOR THE IMPROVEMENT OF THE
DOWNTOWN WEST UTILIDOR
NOTES, LEGEND, AND
ABBREVIATIONS

LIDOR	PROJECT #	
	PROJECT INSPECTOR: VOICEMAIL:	
CALIFORNIA		

**LEGEND** 

PROPERTY LINE

RIGHT OF WAY EASEMENT

SIDEWALK

CENTERLINE

**CURB AND GUTTER** 

STREET MONUMENT

SANITARY SEWER

SANITARY LATERAL

STORM DRAIN LINE

WHEELCHAIR RAMP

AC PAVEMENT OVERLAY

AC DEEP LIFT (AC PLUG)

WATER SERVICE AND METER

AC PAVEMENT GRIND

SAWCUT LINE

WATER MAIN

WATER VALVE

RECLAIMED WATER

FIRE HYDRANTS

STREET SIGN

ELECTROLIER

UTILITY POLE

STREET LIGHT

PULL BOX

OVERHEAD

COMCAST

FIBER OPTIC

ELECTRICAL

THERMAL PIPE

GAS

AT&T

DETAIL CALLOUT

DRIVEWAY

TREE

STORM DRAIN MANHOLE

STORM DRAIN CURB INLET

STORM DRAIN FIELD INLET

SANITARY SEWER MANHOLE

SANITARY SEWER CLEAN OUT

PROJECT BOUNDARY

PROPOSED

\_\_\_\_\_

\_\_\_\_\_

-----

-----RW-----

\_\_\_\_\_FO\_\_\_\_

AUTOMATED WASTE COLLECTION SYSTEM — — — —

A ——DETAIL

3 <del>/---</del>SHEET NUMBER

**EXISTING** 

\_\_\_\_\_\_

PERMIT #	PROJECT ENGINEER		DEPARTMENT OF TRANSPORTATION - OPS	
PROJECT #	NAME	DATE	NAME	DATE
PROJECT INSPECTOR:	DEPARTMENT OF TRANSPORTA	TION	STREETLIGHT LAYOUT	
VOICEMAIL:	NAME	DATE	NAME	DATE
	MUNICIPAL WATER		ELECTRICAL CIRCUITS	
	NAME	DATE	NAME	DATE

	T ANCLE DOINT
ANG F	T ANGLE POINT AIR RELEASE VALVE
AWCS	
BC	BEGIN CURVE
ВОА	BLOW OFF ASSEMBLY
BOW	BACK OF WALK
BW	BOTTOM OF WALL
⊙ CL/Ç	CENTER LINE
CSJ	CITY OF SAN JOSE DETAIL
DIP	DUCTILE IRON PIPE
SS(E) <b>DW</b>	DRIVEWAY
EC	END CURVE
ELEC	ELECTRIC
EL/ELI	
EP	EDGE OF PAVEMENT
O ER	END OF RETURN
SD(E) ESMT	EASEMENT
□ <b>/</b> /(□)	EXISTING
© FG	FINISHED GRADE
FH △ FL	FIRE HYDRANT
F00/F	FLOW LINE
G FOC/F	C FACE OF CURB GAS
/ GB	GRADE BREAK
HORIZ	
— HP	HIGH POINT
INV	INVERT
IRR	IRRIGATION
JT	JOINT TRENCH
LP	LOW POINT
LT, RT	
( • ) MUTC	CALIFORNIA MANUAL ON UNIFORM TRAFFIC CONTROL DEVICES
MIN	MINIMUM
NTS	NOT TO SCALE
PCC	POINT OF COMPOUND CURVATURE
PI	POINT OF INTERSECTION
P/PL	PROPERTY LINE
POC	POINT ON CURVE
PRC	POINT OF REVERSE CURVE
PSE	PUBLIC SERVICE EASEMENT
PUE PVMT	PUBLIC UTILITY EASEMENT PAVEMENT
RAD/R	—
(D)	REMOVE
	REINFORCED CONCRETE PIPE
⊠ RCW	RECLAIMED WATER
DAM	RIGHT OF WAY
	SLOPE
SD	STORM DRAIN
SDCB	STORM DRAIN CATCH BASIN
SDCI	STORM DRAIN CURB INLET
	STORM DRAIN FIELD INLET
SDJB	STORM DRAIN JUNCTION BOX
SDMH	
SL	STREET LIGHT
SS	SANITARY SEWER
SSCO	SANITARY SEWER CLEANOUT
SSFI SSEM	SANITARY SEWER FLUSHING INLET
OOI IVI	SANITARY SEWER FORCE MAIN
——————————————————————————————————————	SANITARY SEWER MANHOLE
——OH(E)————————————————————————————————————	STATION STANDARD
OW	STANDARD SIDEWALK
AT&T(E)	SIDEWALK TO BE DETERMINED
——COMCAST(E)—— TBV	TO BE VERIFIED
TC	TOP OF CURB
——FO(E) —— TDC	TOP OF DEPRESSED CURB
——————————————————————————————————————	THERMAL PIPE
TRC	TOP OF ROLLED CURB
TVC	TOP OF VERTICAL CURB
TW	TOP OF WALL
VERT	VERTICAL
VCP	VITRIFIED CLAY PIPE
	WATER
W	
WM	WATER METER
	WATER METER WATER VALVE

**ABBREVIATIONS** 

ABANDONED

ASPHALTIC CONCRETE

ABN

AC

San Jose, CA 95131

HMHca.com


SAN JOSE

DEPARTMENT OF PUBLIC WORKS

APPROVED BY MATTHEW CANO DIRECTOR OF PUBLIC WORKS

PIPE SIZE	LIMITS OF X		
	MINIMUM	MAXIMUM	
24" OR LESS	4"	4" + O.D.	
27" AND GREATER	6"	6" + O.D.	

BEDDING TYPE	CATEGORY OF PIPE
Α	VITRIFIED CLAY PIPE, CONCRETE PIPE 25" DIA. AND GREATER
В	CONCRETE PIPE 24" DIA. AND LESS
С	DUCTILE IRON PIPE

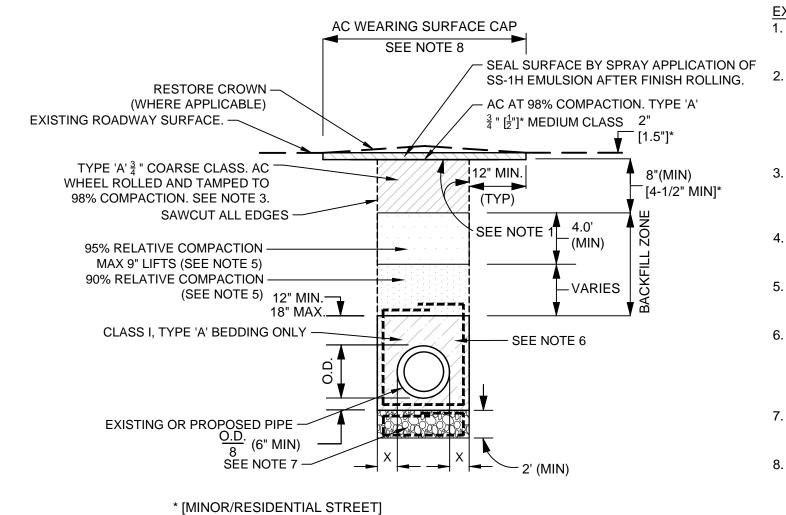

EXISTING STREET TRENCH NOTES:

CLEAN AND TACK COAT ON BOTH SIDES OF EXCAVATED TRENCH & BETWEEN AC COURSES WITH SPRAY APPLICATION OF SS-1H BINDER BEFORE PLACING AC SURFACE.

2. PLACE A TOTAL OF 10" OR EXISTING +3" AC BASE TO FINISH GRADE, WHICHEVER THICKNESS IS GREATER. AC BASE SHALL BE PLACED IN A MINIMUM OF 2 LIFTS. GRIND ENTIRE WEARING SURFACE CAP WIDTH INCLUDING AC BASE AND EXISTING SURFACE TO DEPTH OF 2" [1.5"]\* BELOW FINISH GRADE JUST PRIOR TO PLACING AC SURFACE.

3. 2" [1.5"]\* SURFACE CAP SHALL BE PLACED THE SAME DAY AS THE PAVEMENT GRINDING, OR COVERED WITH NON-SKID STEEL PLATES COUNTERSUNK FLUSH WITH THE ADJACENT GRADES UNTIL THE AC SURFACE CAN BE PLACED.

4. SHOVEL - SLICING OF BEDDING MATERIAL IN THE HAUNCH AREAS IS REQUIRED WHEN BEDDING IS NO HIGHER THAN THE QUARTER POINT OF THE PIPE.
5. THE CONTRACTOR SHALL USE CLASS III AGGREGATE BASE, 3/4"

MAXIMUM GRADATION AS BACKFILL MATERIAL AND SHALL CONFORM TO SECTION 26 OF THE STANDARD SPECIFICATIONS.


6. GEOTEXTILE TO BE PLACED BETWEEN CLASS III AB AND BEDDING

IF THE NATIVE SOIL SURROUNDING THE TRENCH IS FOUND TO BE HEAVY CLAY. FOR ALL OTHER NATIVE SOIL CONDITIONS THE GEOTEXTILE SHALL BE WRAPPED AROUND THE ENTIRE TRENCH AS SHOWN.

 GEOTEXTILE AND CLASS I, BEDDING STABILIZATION MATERIAL SHALL BE USED FOR UNSUITABLE SOIL CONDITIONS ONLY OR AS DIRECTED BY CITY ENGINEER/INSPECTOR.

8. WIDTH OF FINAL AC WEARING CAP SHALL BE 6FT MINIMUM OR THE TRENCH WIDTH PLUS 2 FT MIN, WHICHEVER IS GREATER.

## 2 CSJ EXISTING STREET TRENCH RESTORATION

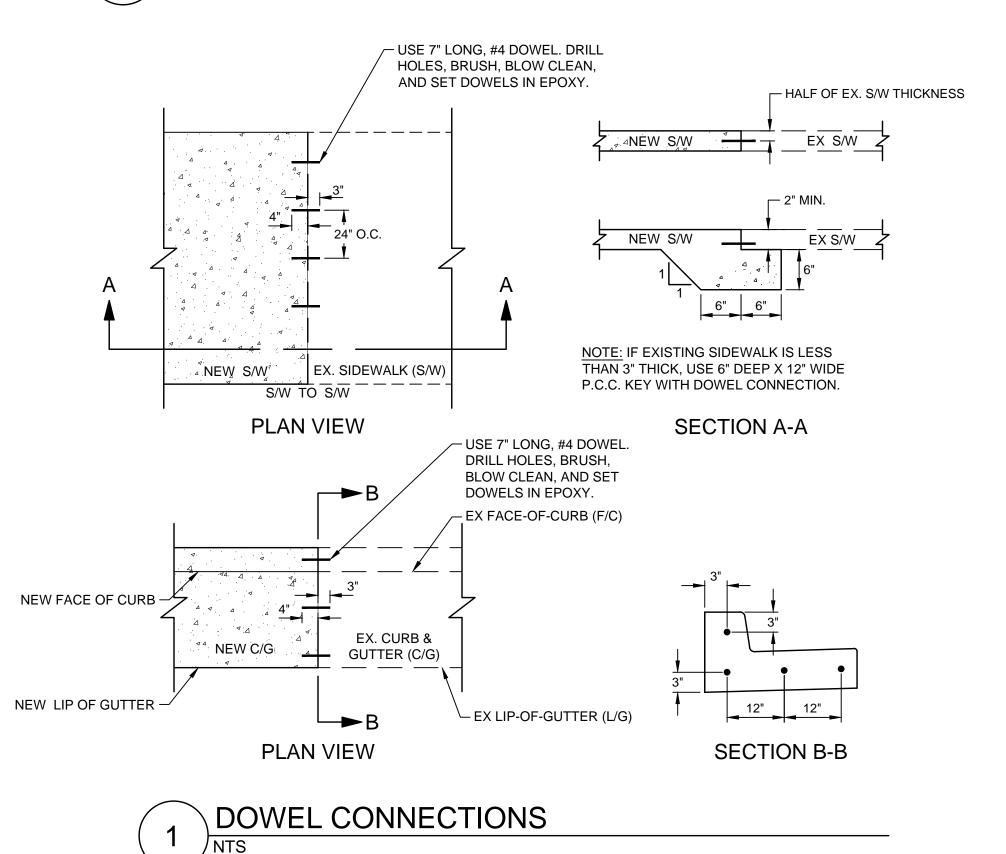



DATE:	MARCH 1, 2021	
SCALE:	NTS	
DESIGNED:	RH	
DRAWN:	LA/RM/JBC/DK	
CHECKED:	VNM	
PROJ. ENGR:	VNM	
FILE:	571900IP.DWG	



PRELIMINARY
NOT FOR CONSTRUCTION

FOR THE IMPROVEMENT OF THE

DOWNTOWN WEST UTILIDOR

DETAILS

SAN JOSE

PERMIT #
PROJECT #

PROJECT INSPECTOR: VOICEMAIL:

CALIFORNIA

NAME
DATE

NAME
DEPARTMENT OF TRANSPORTATION

NAME
DATE

PROJECT ENGINEER

DEPARTMENT OF TRANSPORTATION - OPS


DEPARTMENT OF PUBLIC WORKS


APPROVED BY MATTHEW CANO DIRECTOR OF PUBLIC WORKS


SAN JOSE


CAPITAL OF SILICON VALLEY


SHEET 3 OF 21

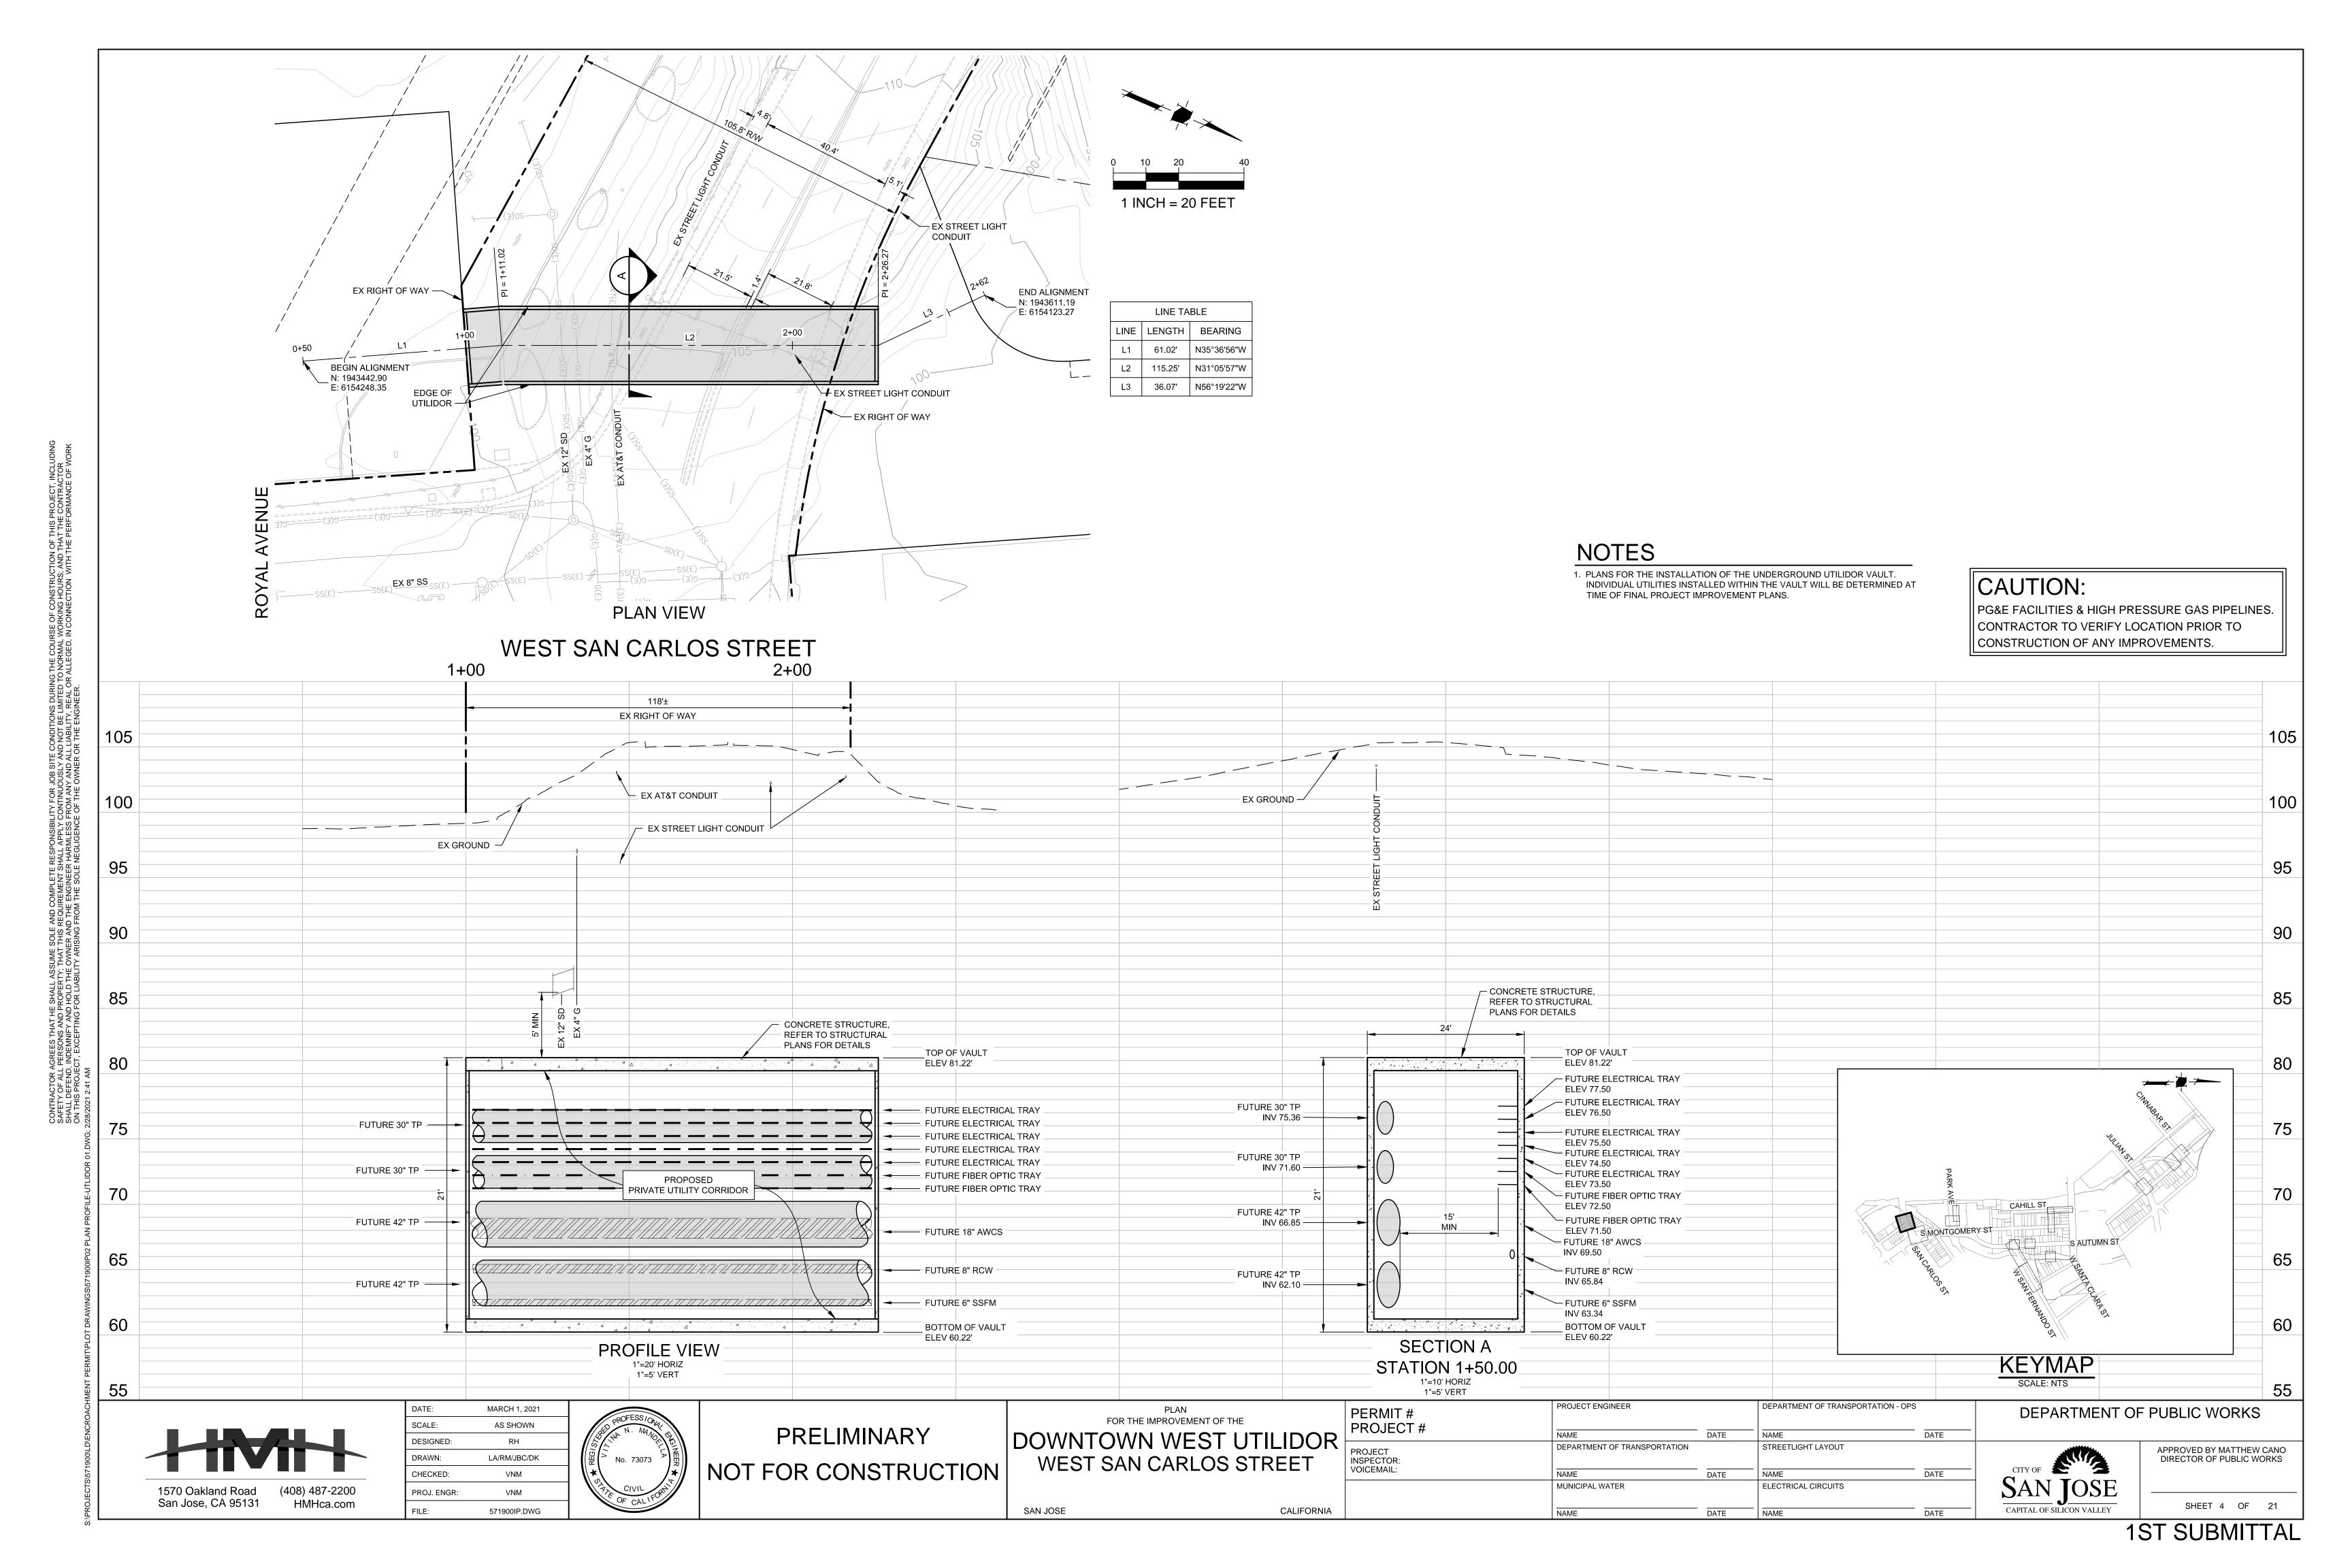


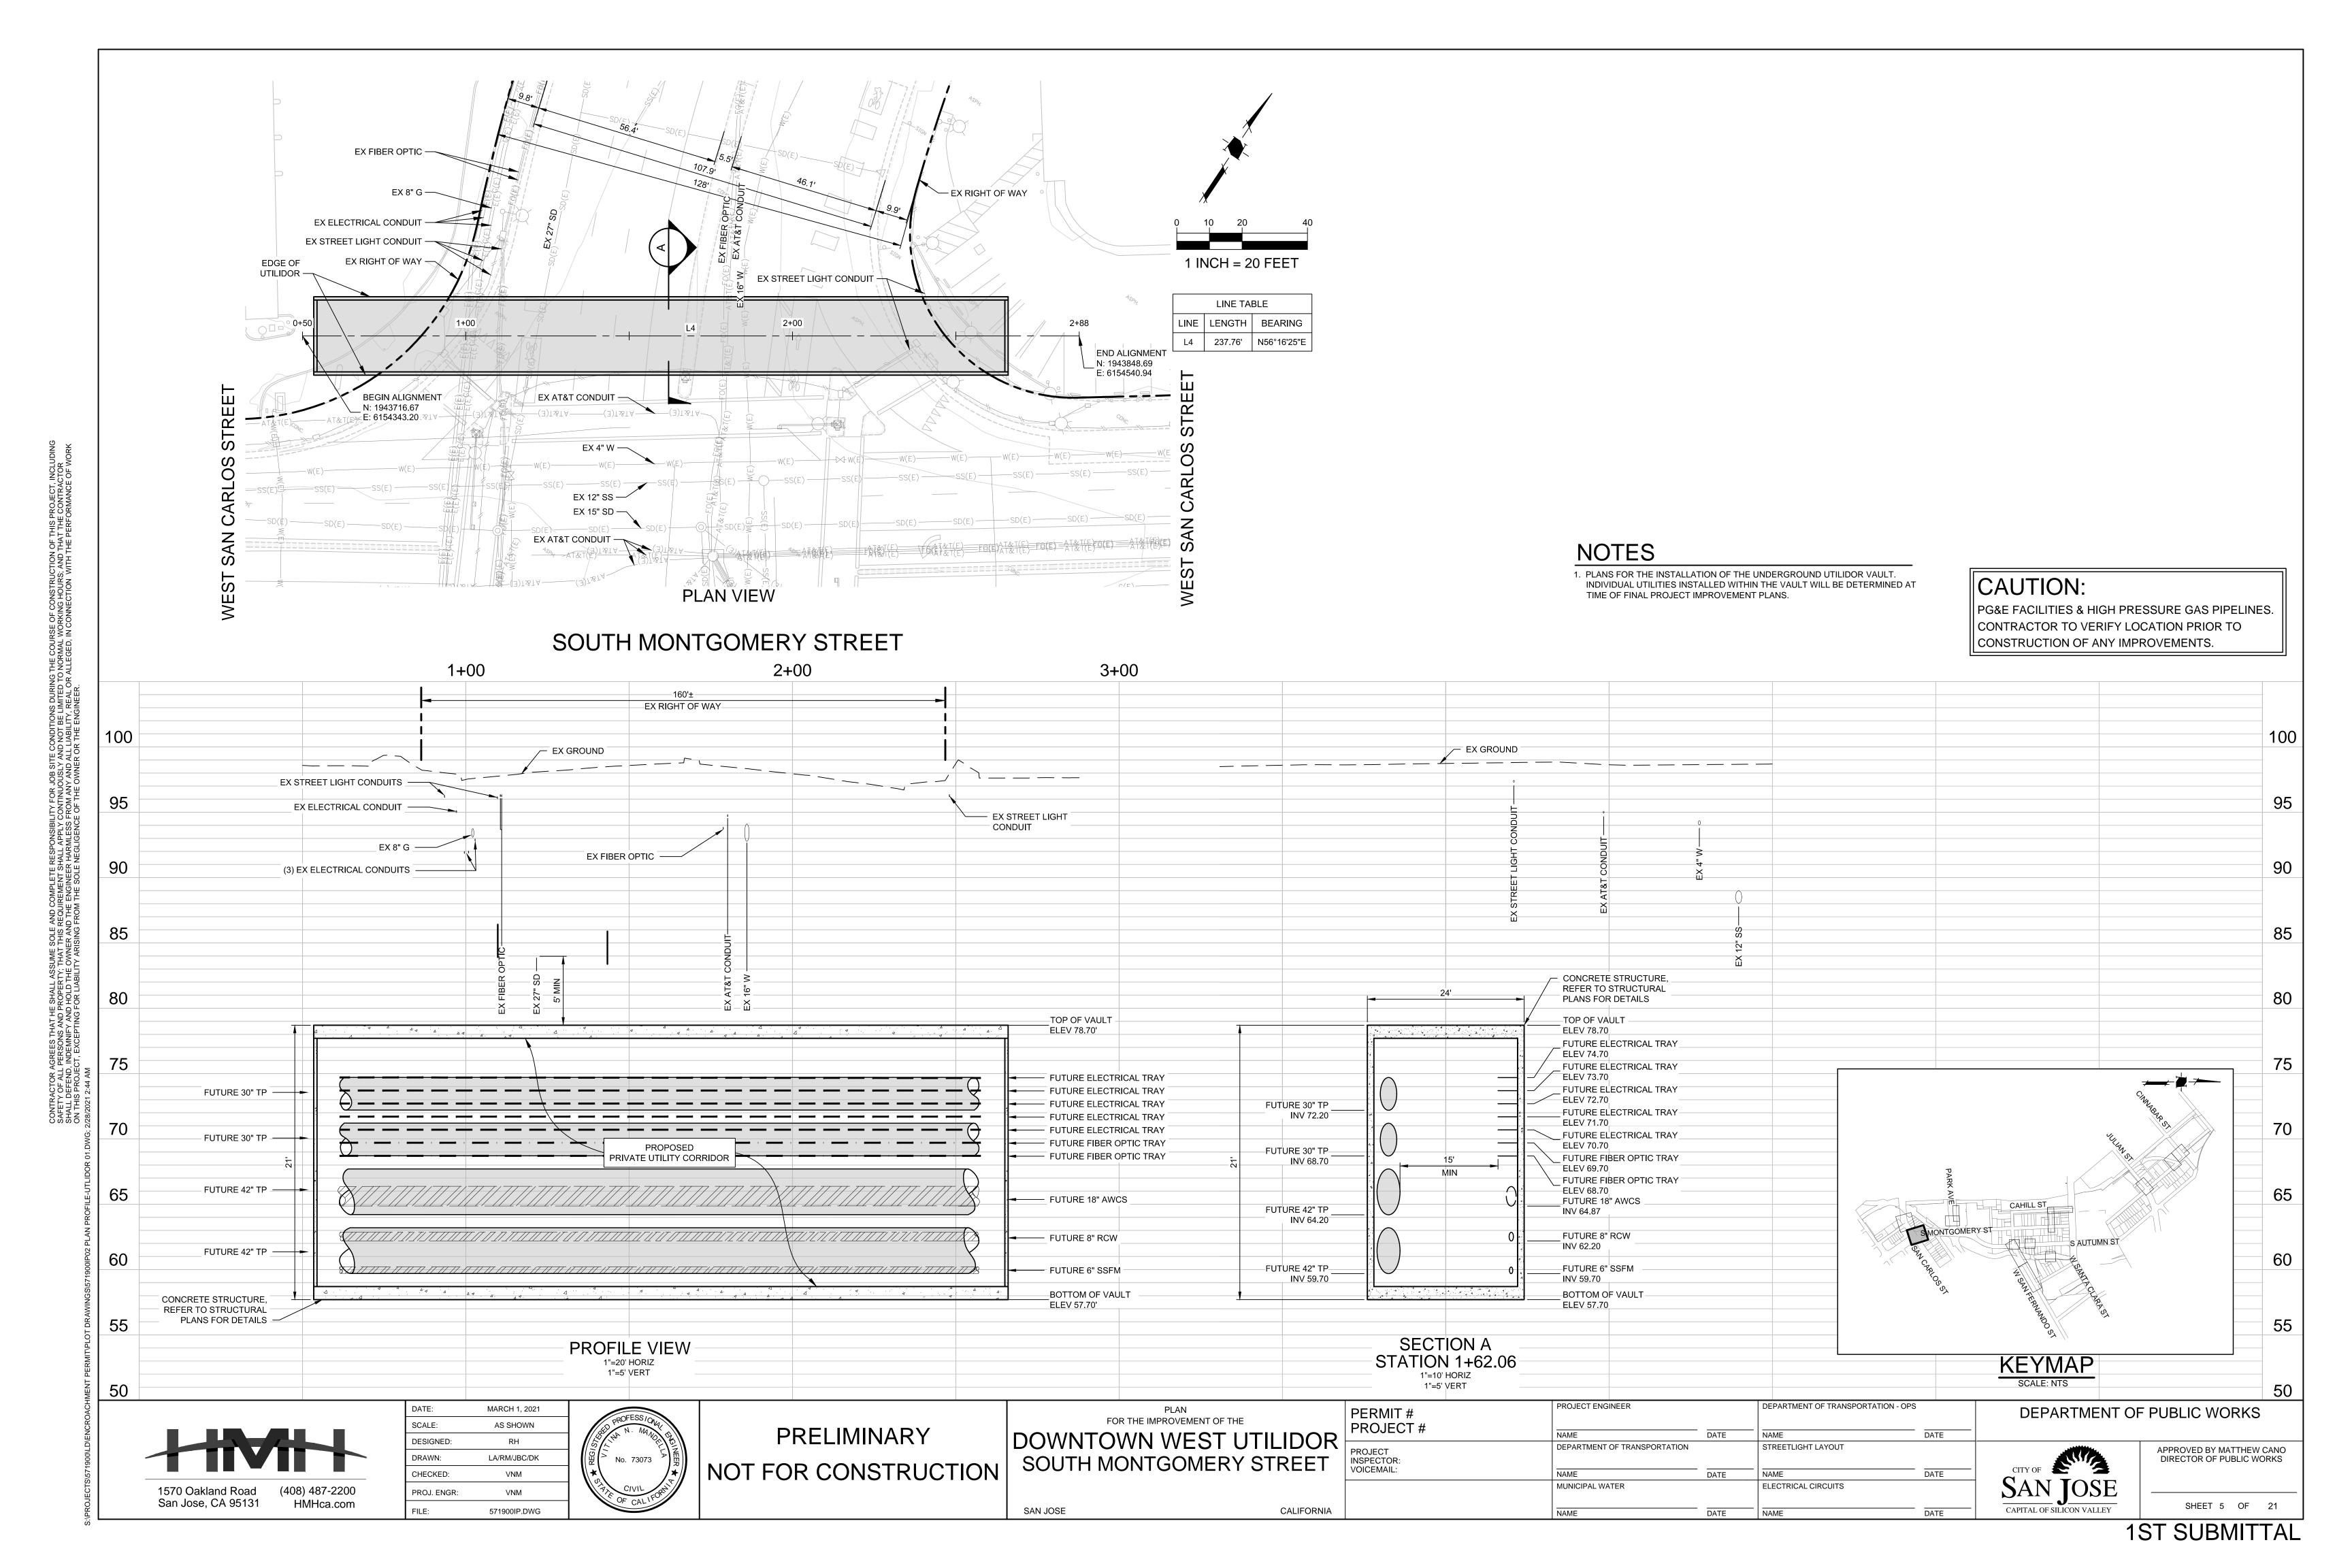


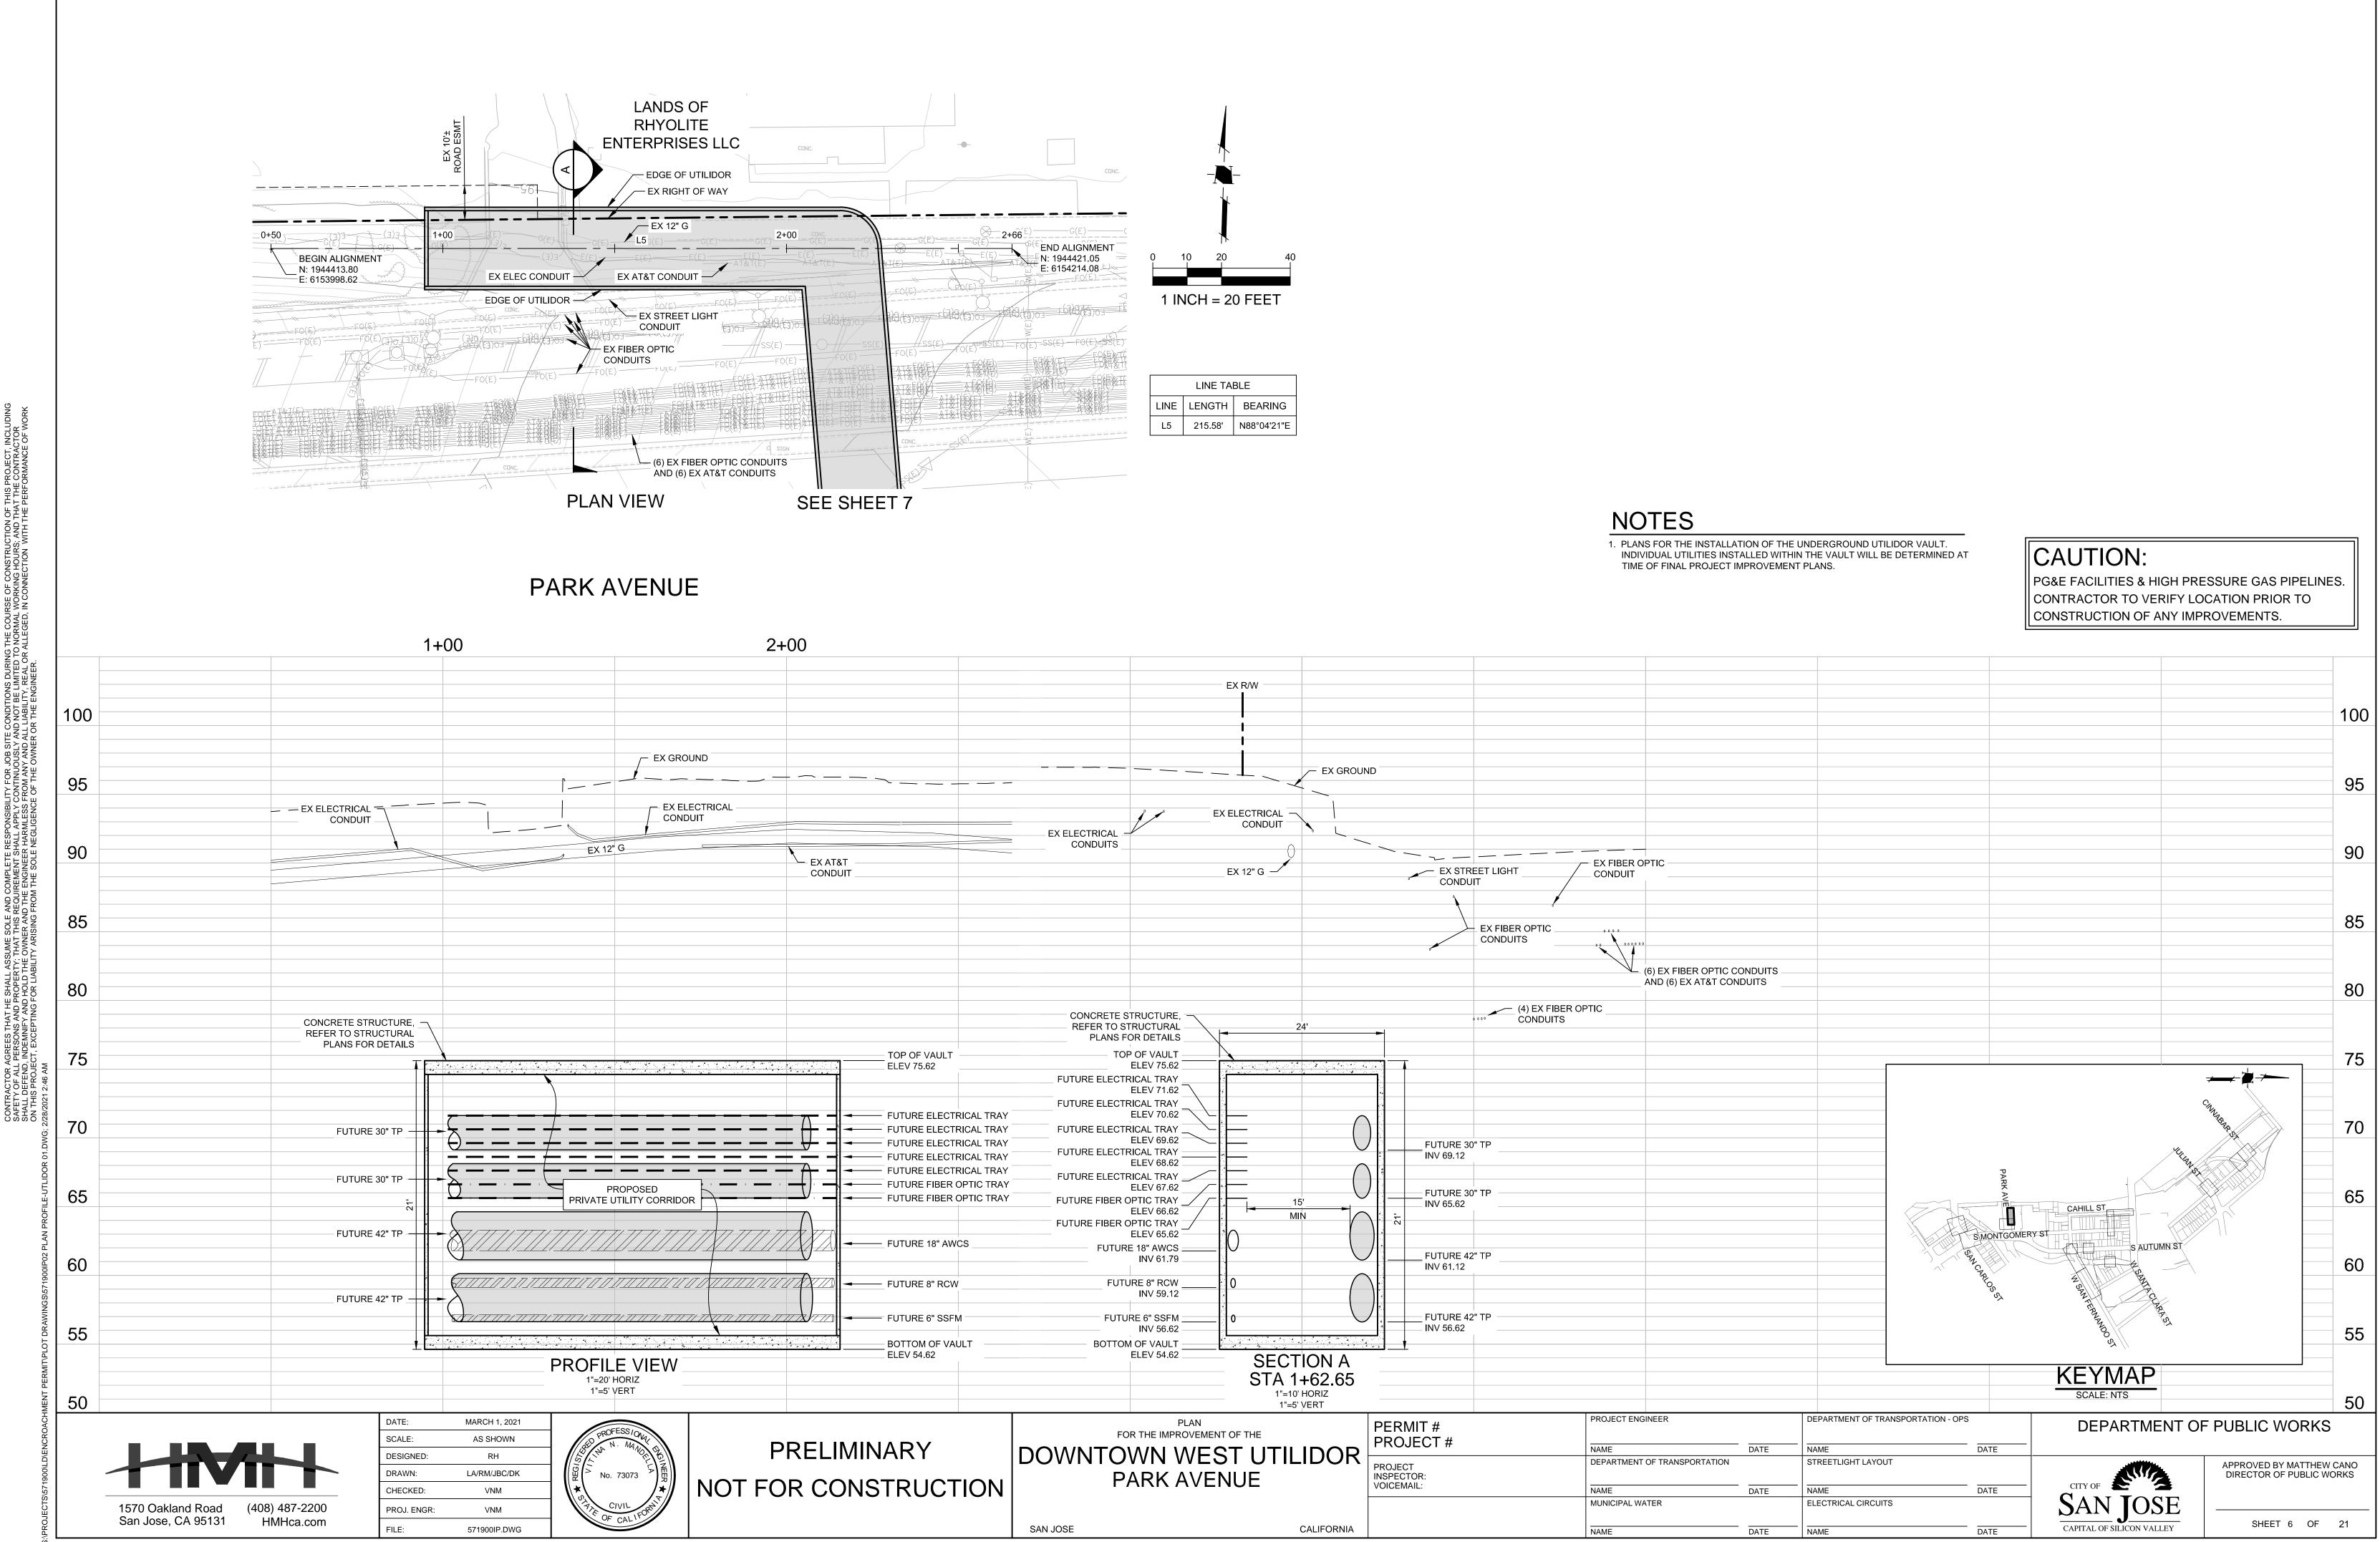


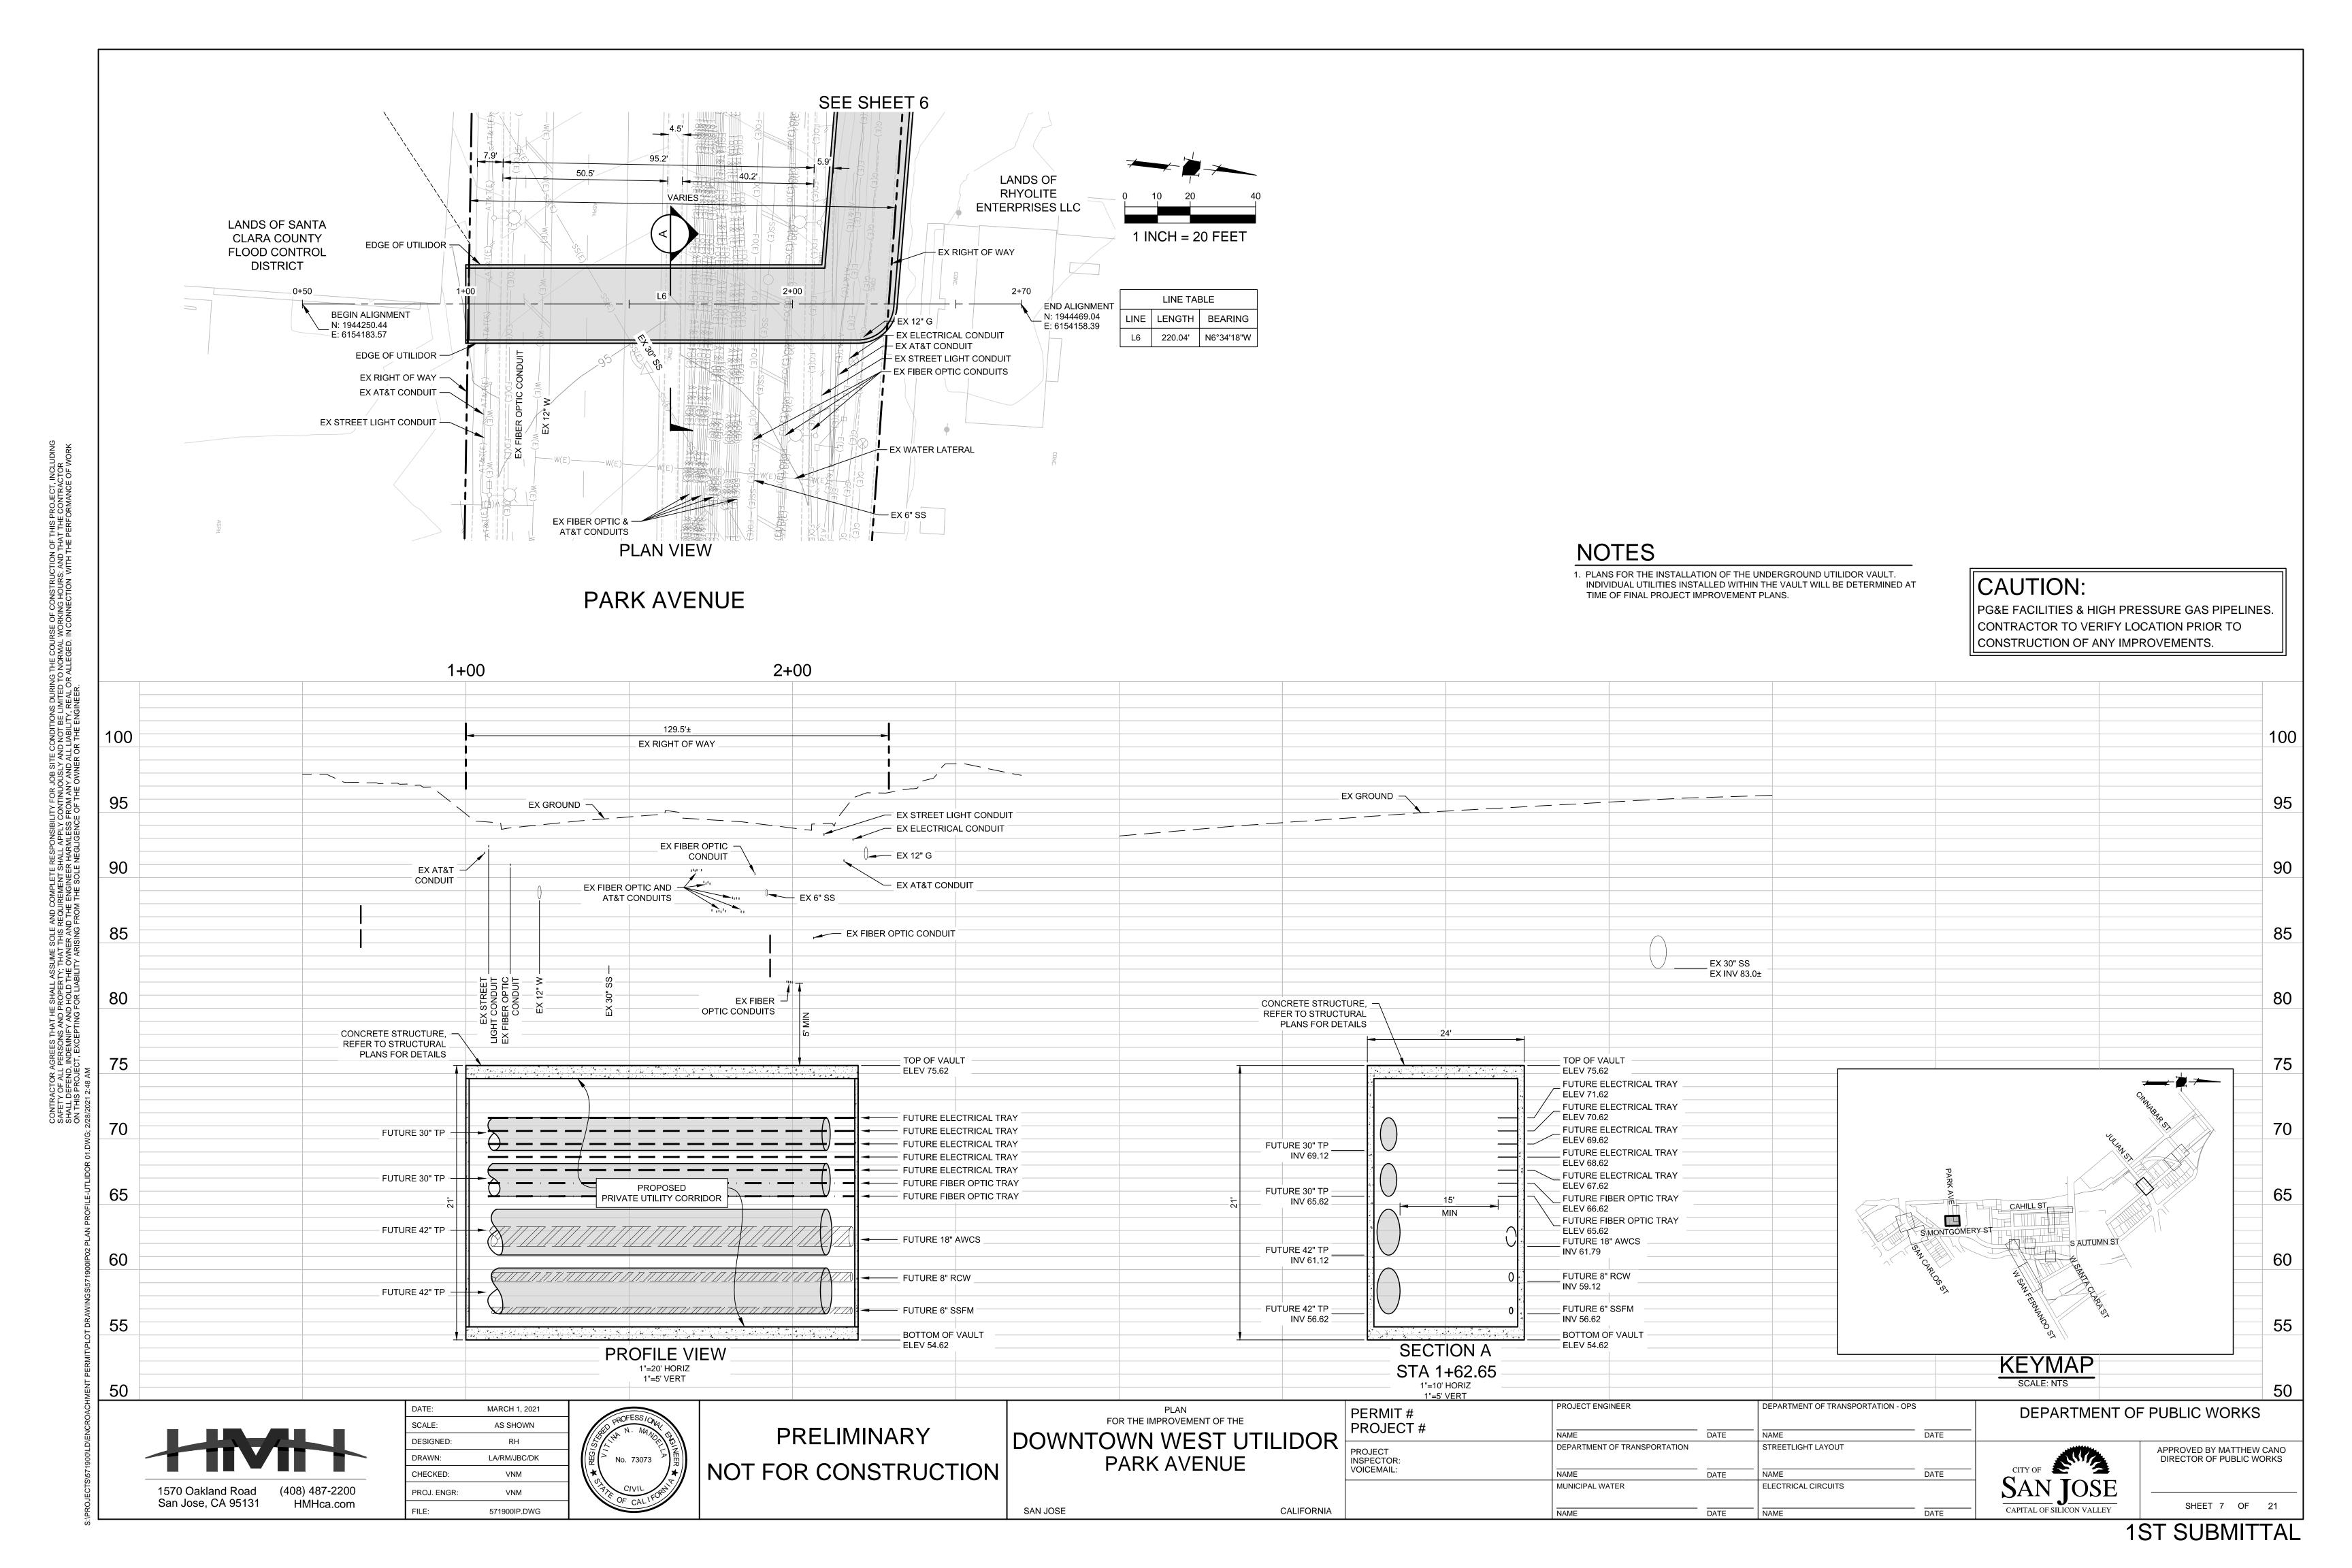

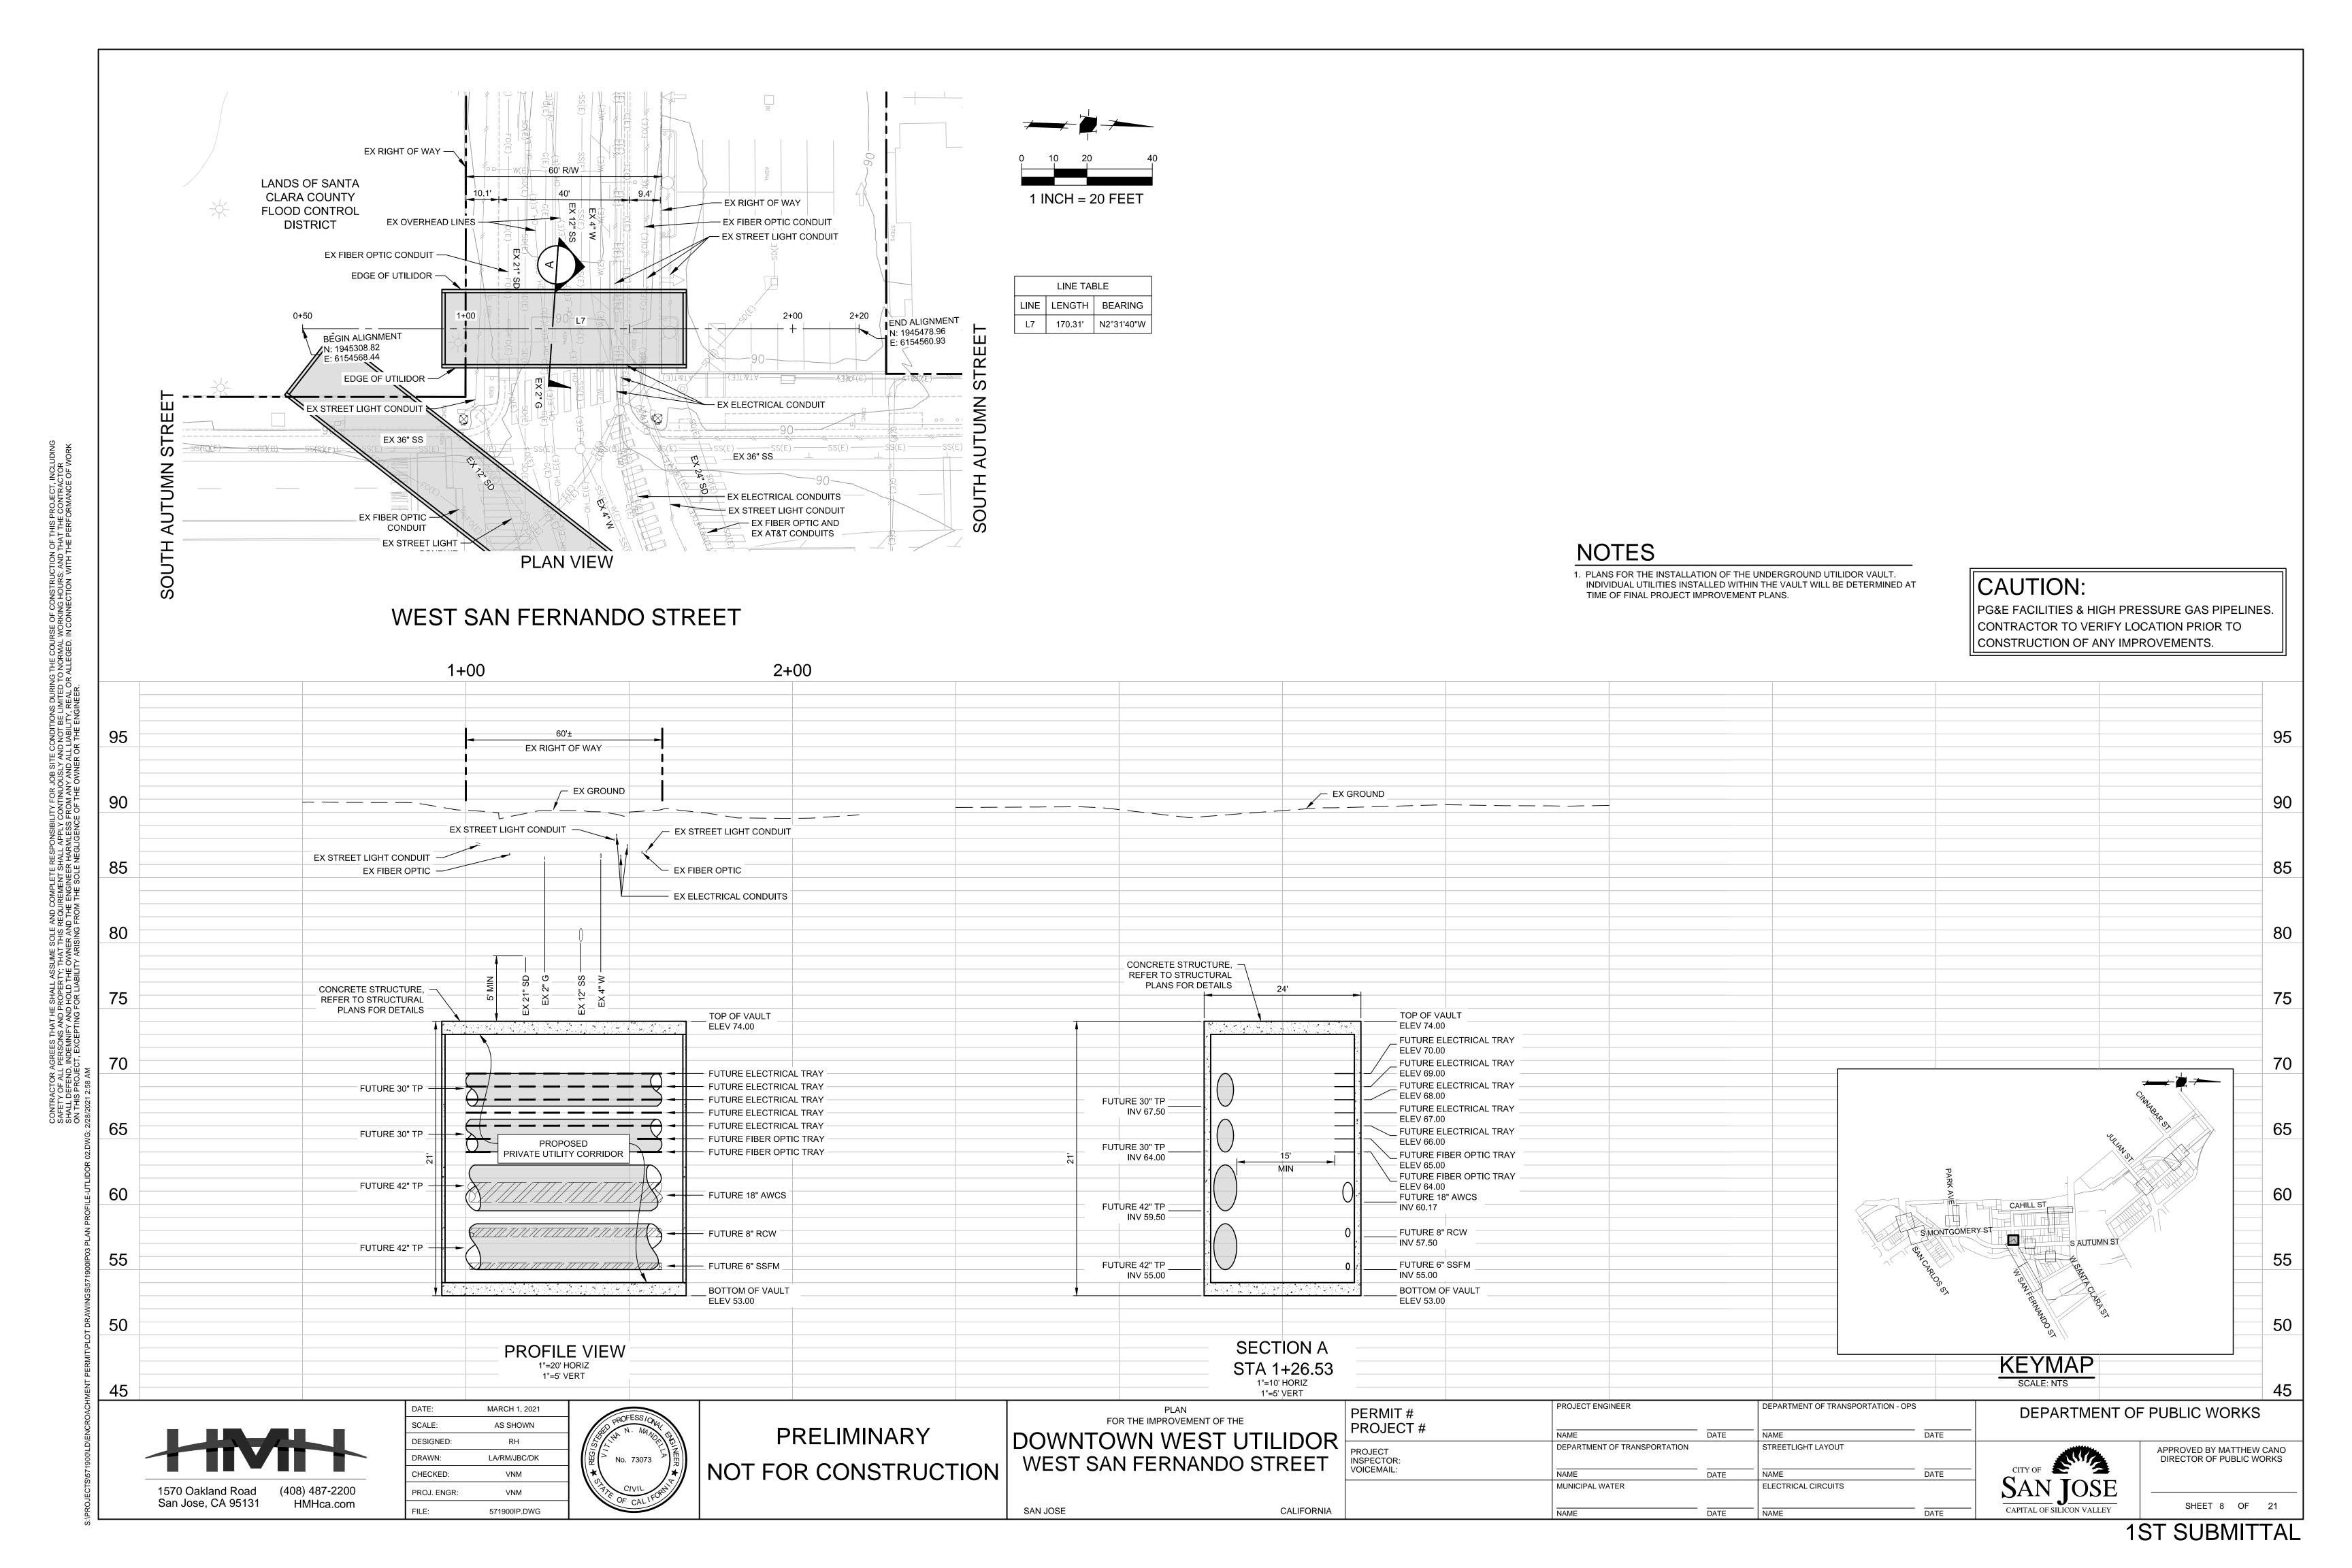

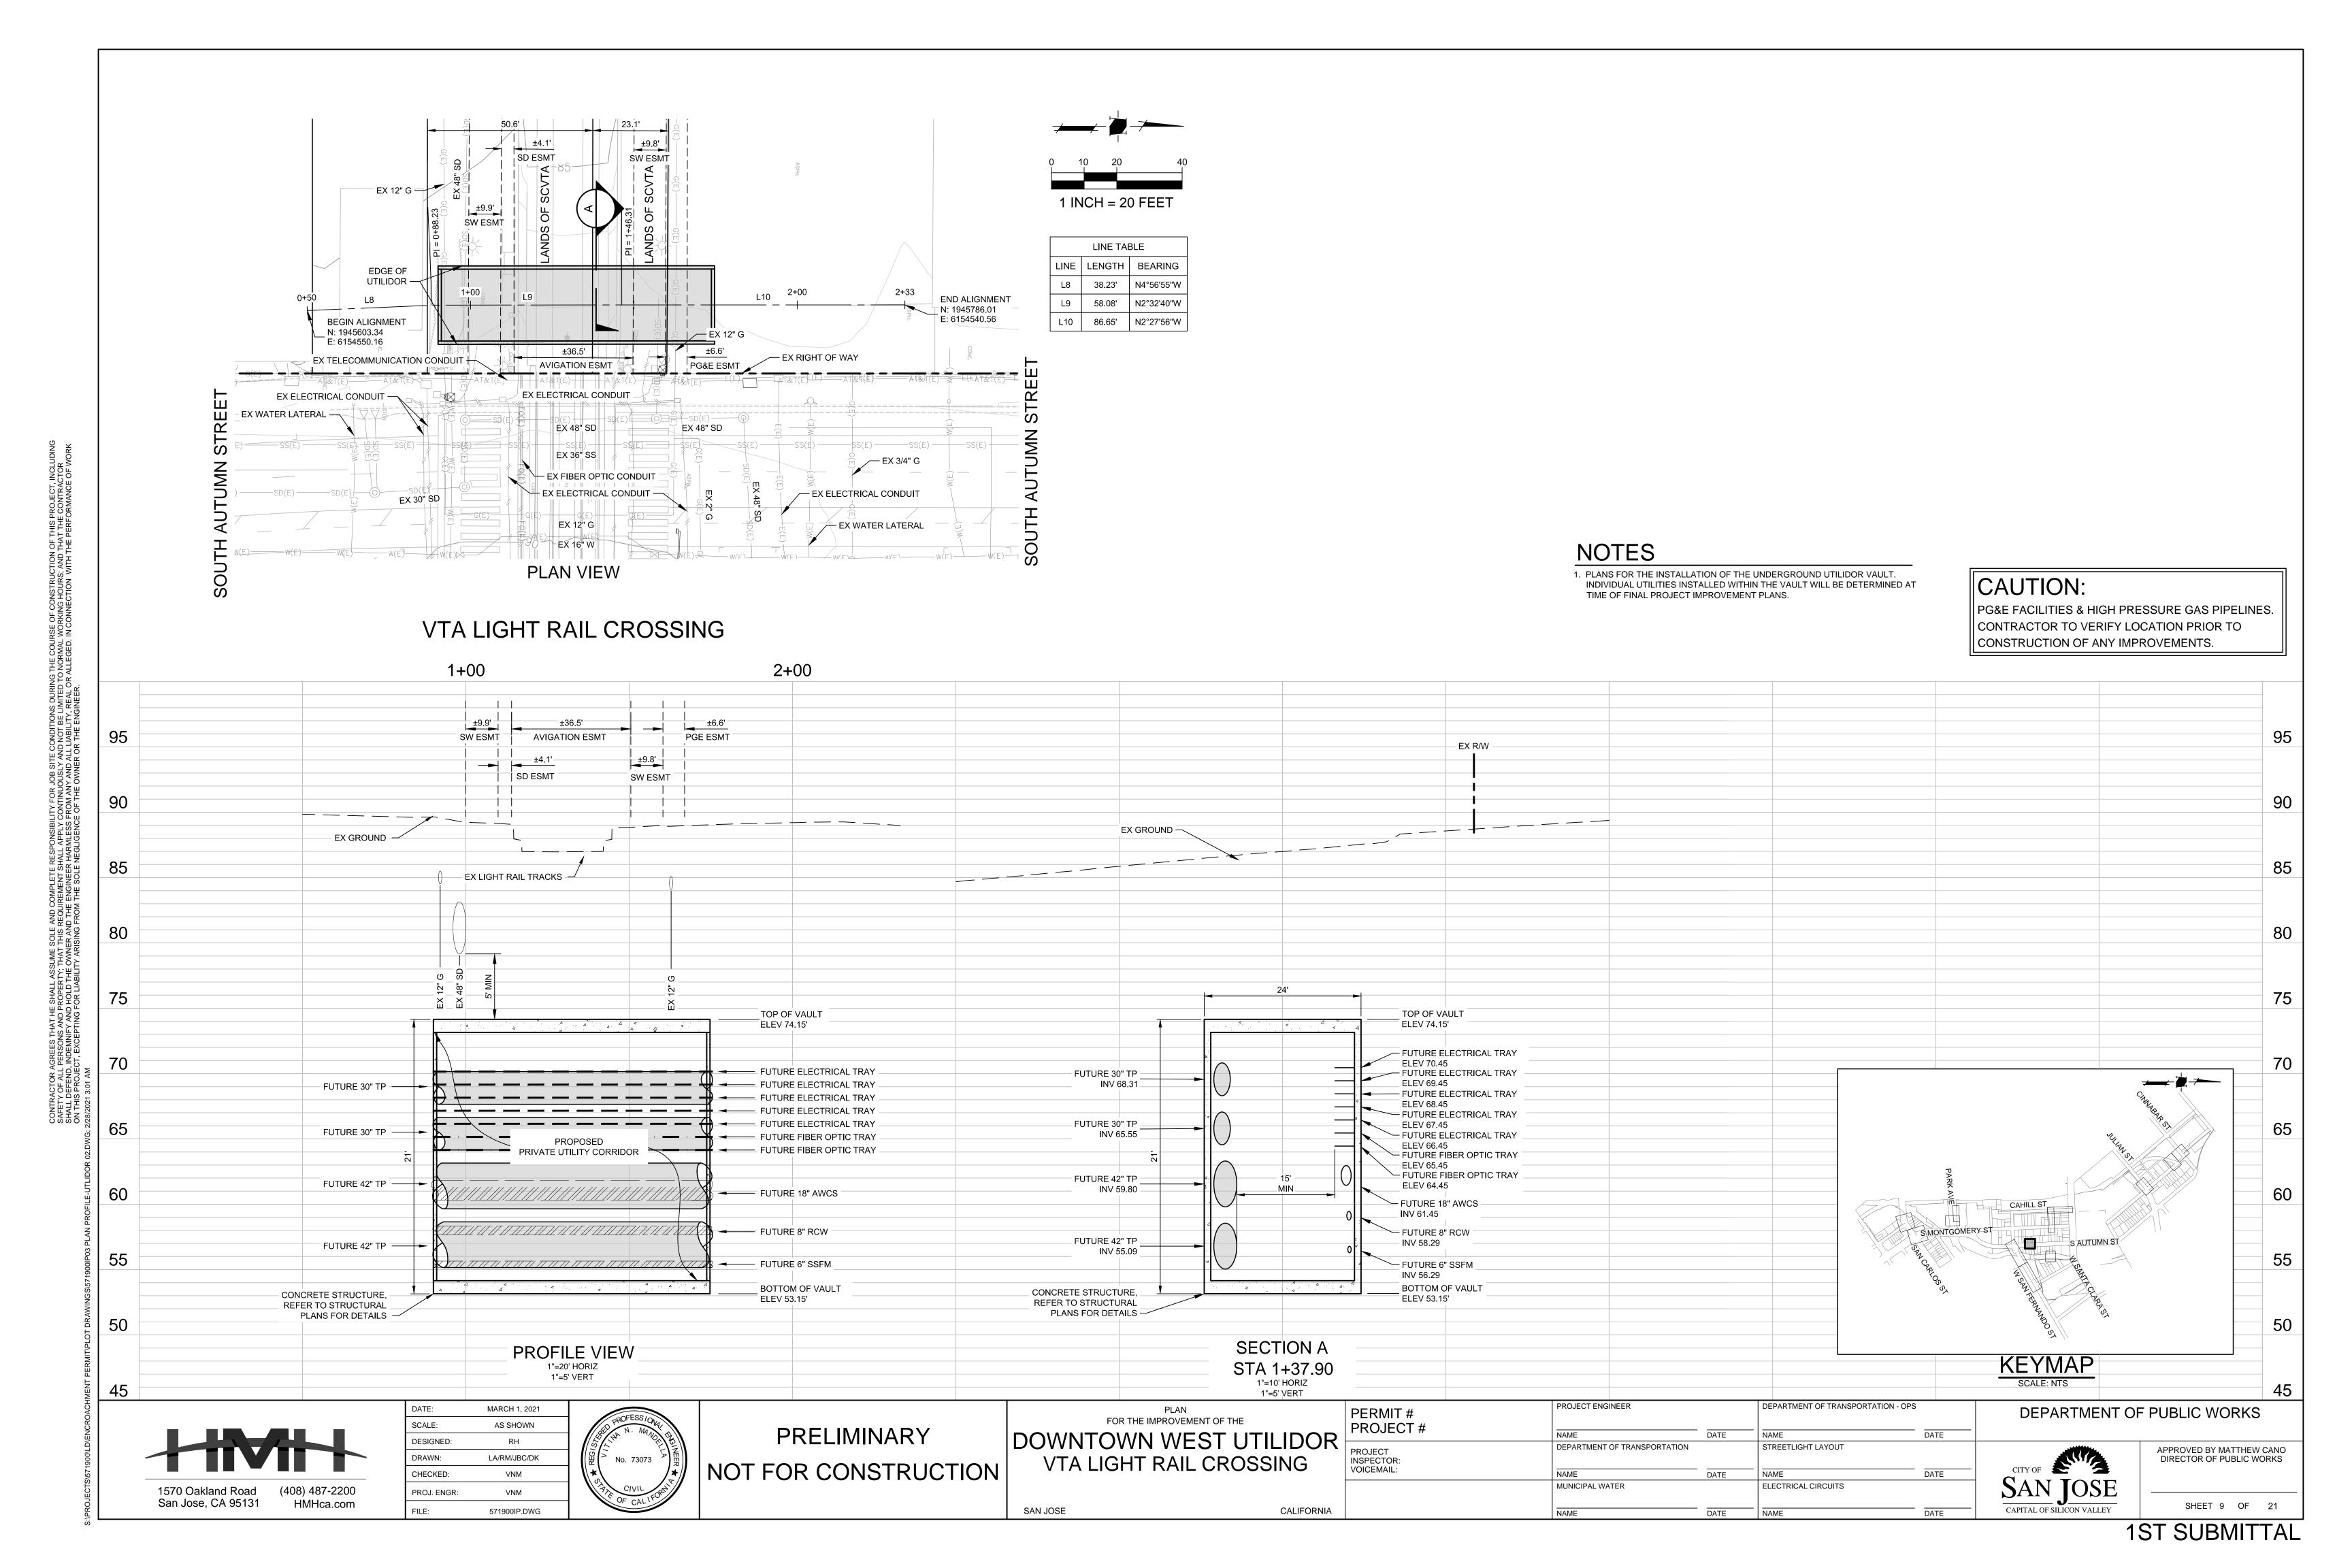

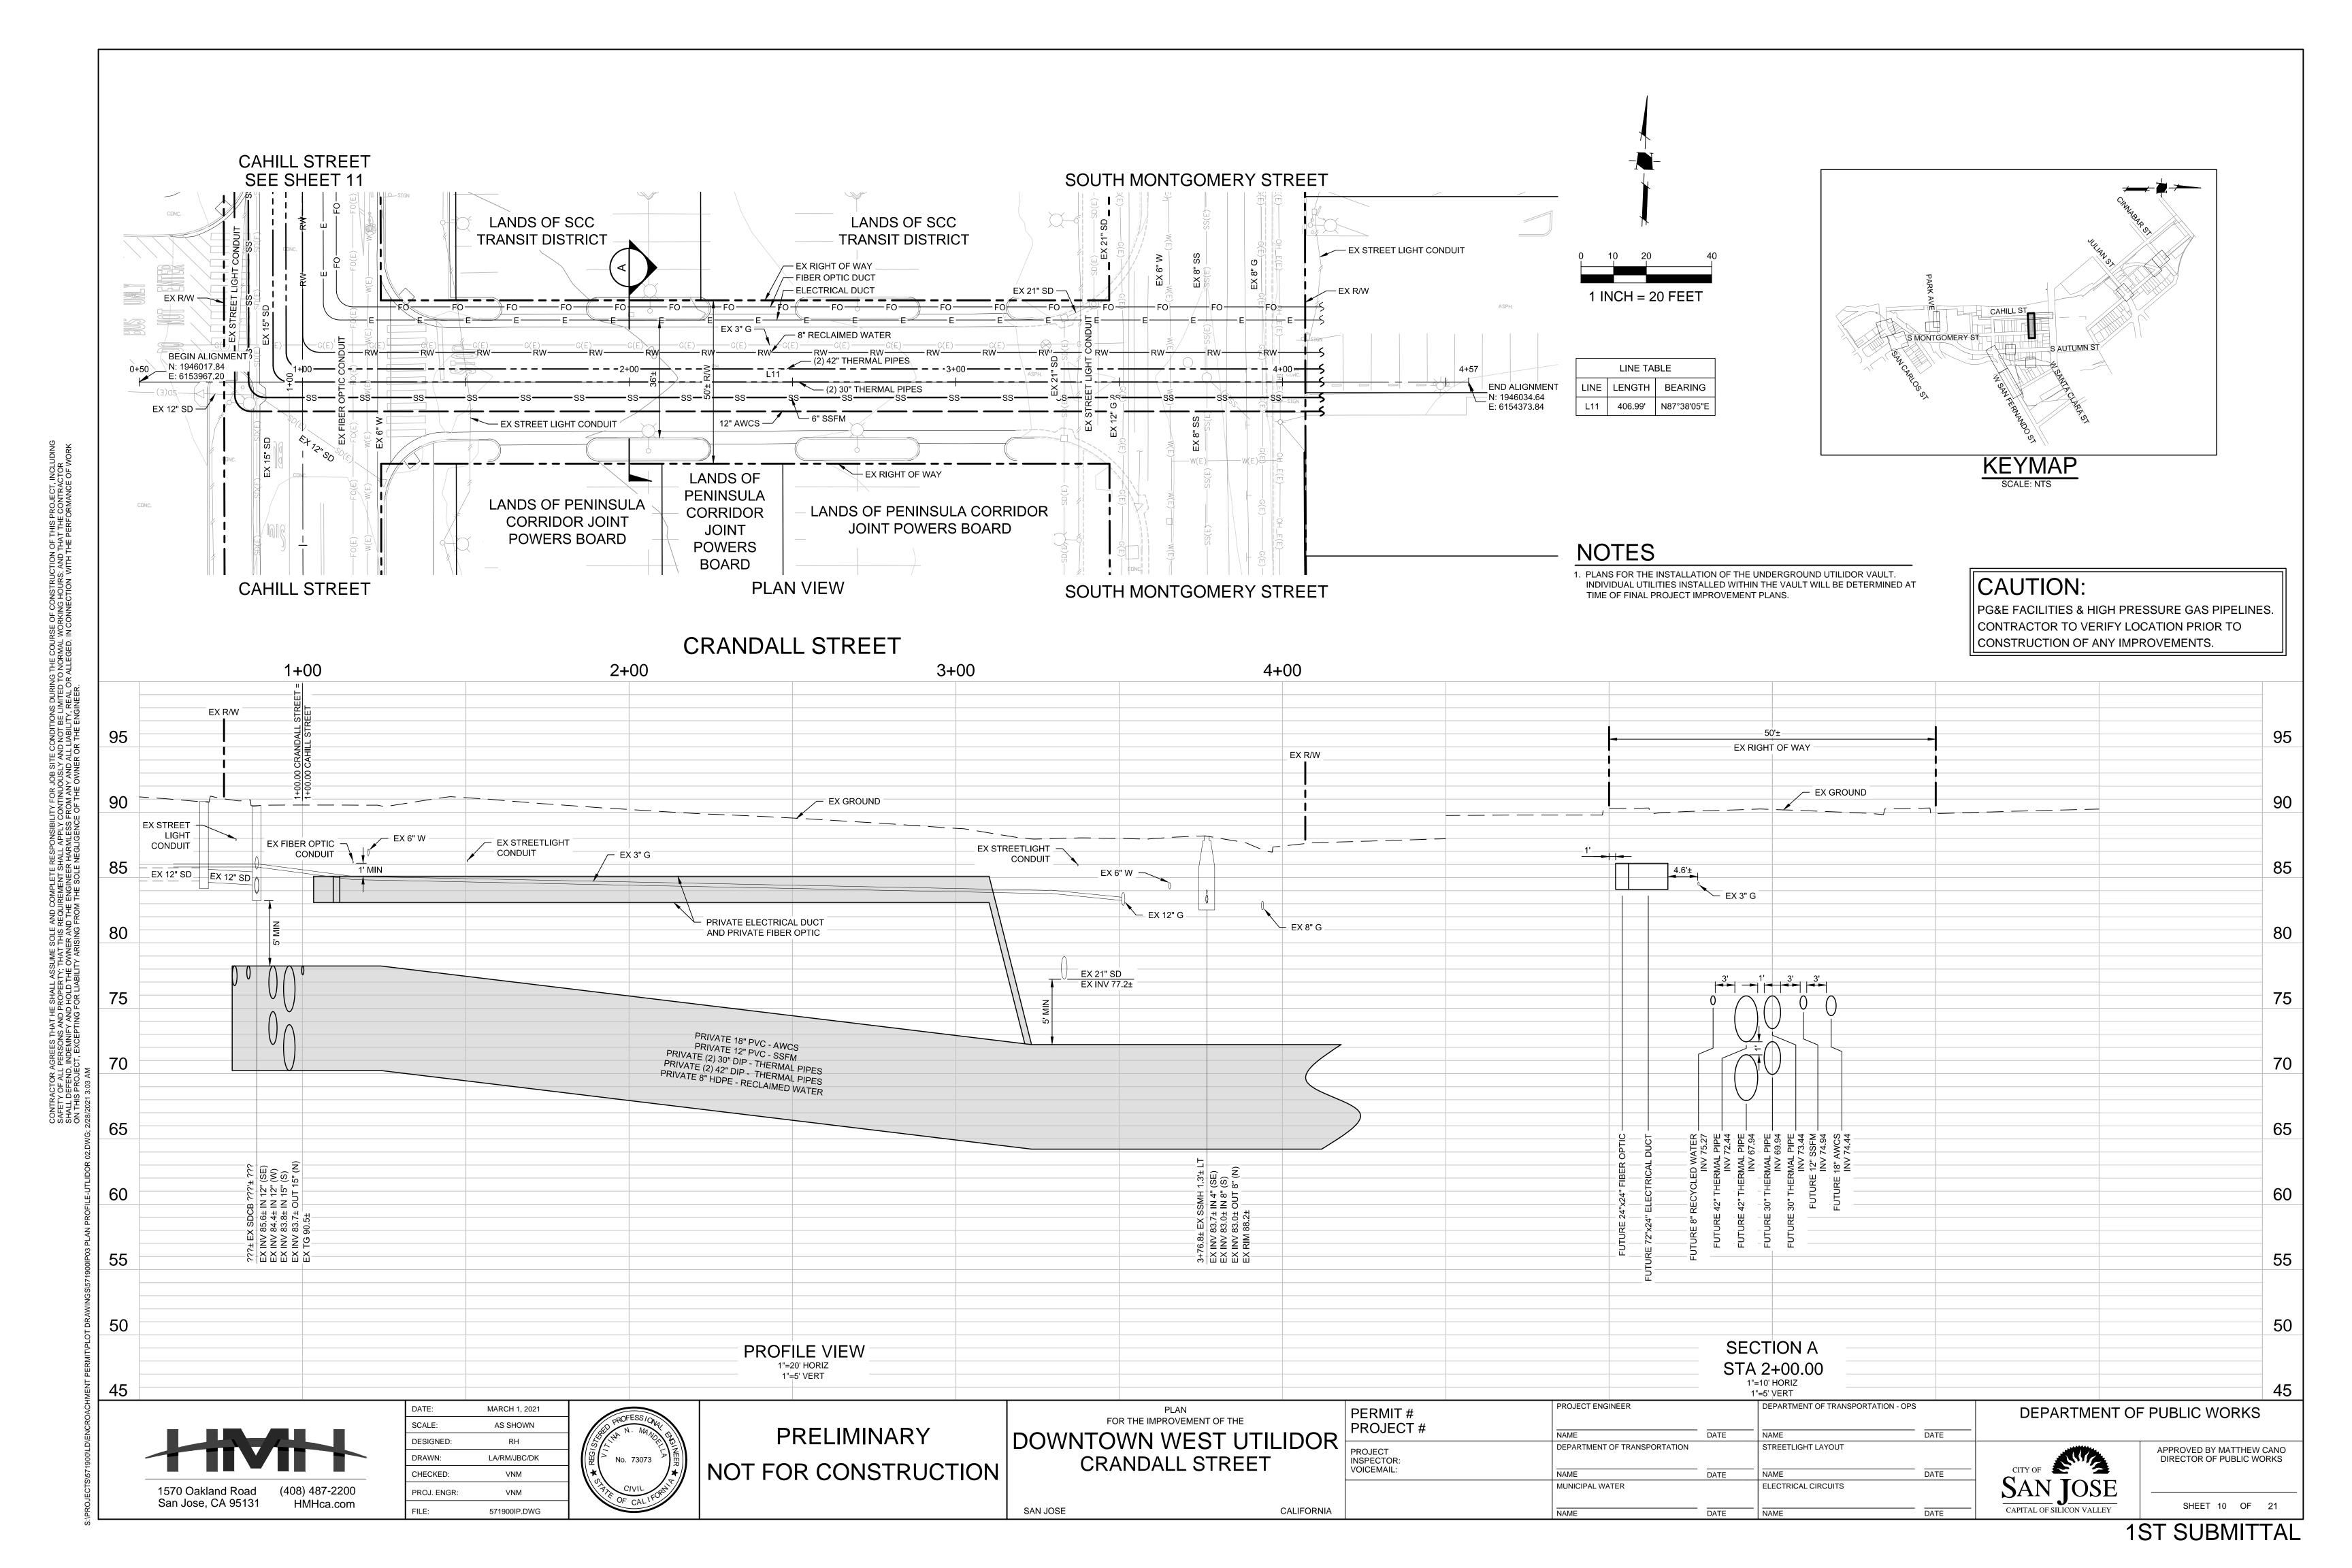

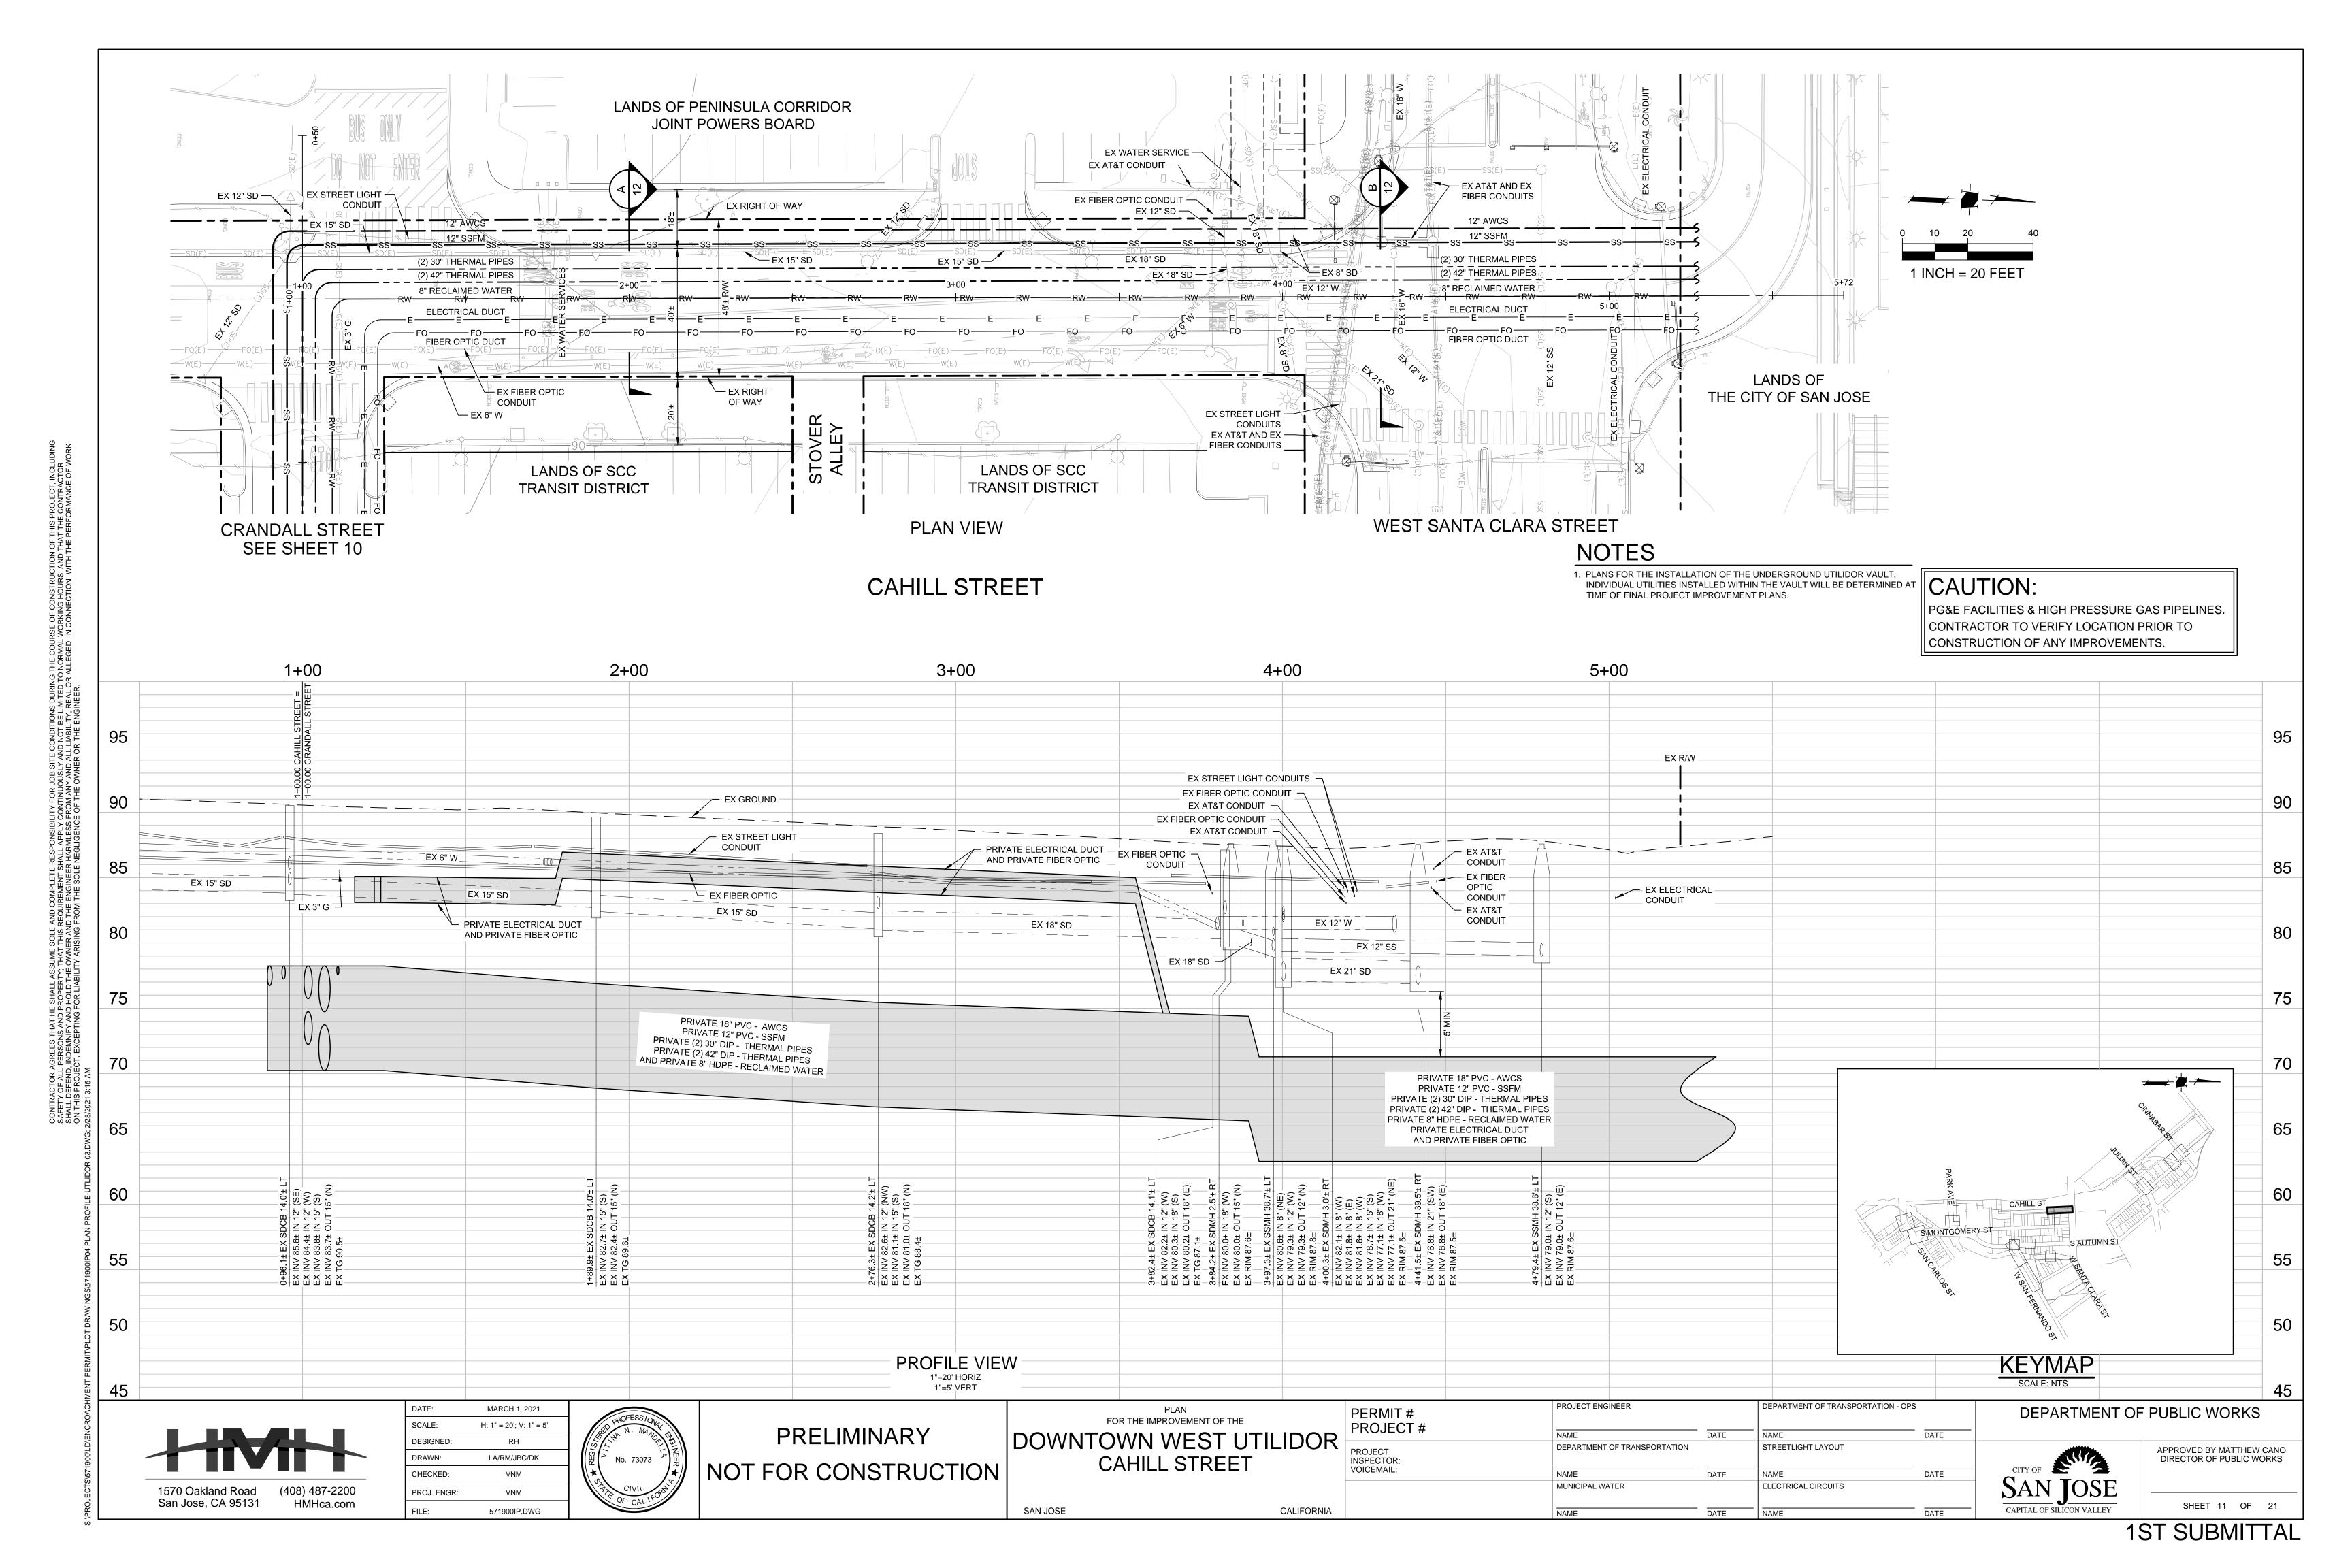

#### NOTES

MUNICIPAL WATER


1. PLANS FOR THE INSTALLATION OF THE UNDERGROUND UTILIDOR VAULT. INDIVIDUAL UTILITIES INSTALLED WITHIN THE VAULT WILL BE DETERMINED AT TIME OF FINAL PROJECT IMPROVEMENT PLANS.

ELECTRICAL CIRCUITS

DATE NAME

#### CAUTION:

PG&E FACILITIES & HIGH PRESSURE GAS PIPELINES. CONTRACTOR TO VERIFY LOCATION PRIOR TO CONSTRUCTION OF ANY IMPROVEMENTS.

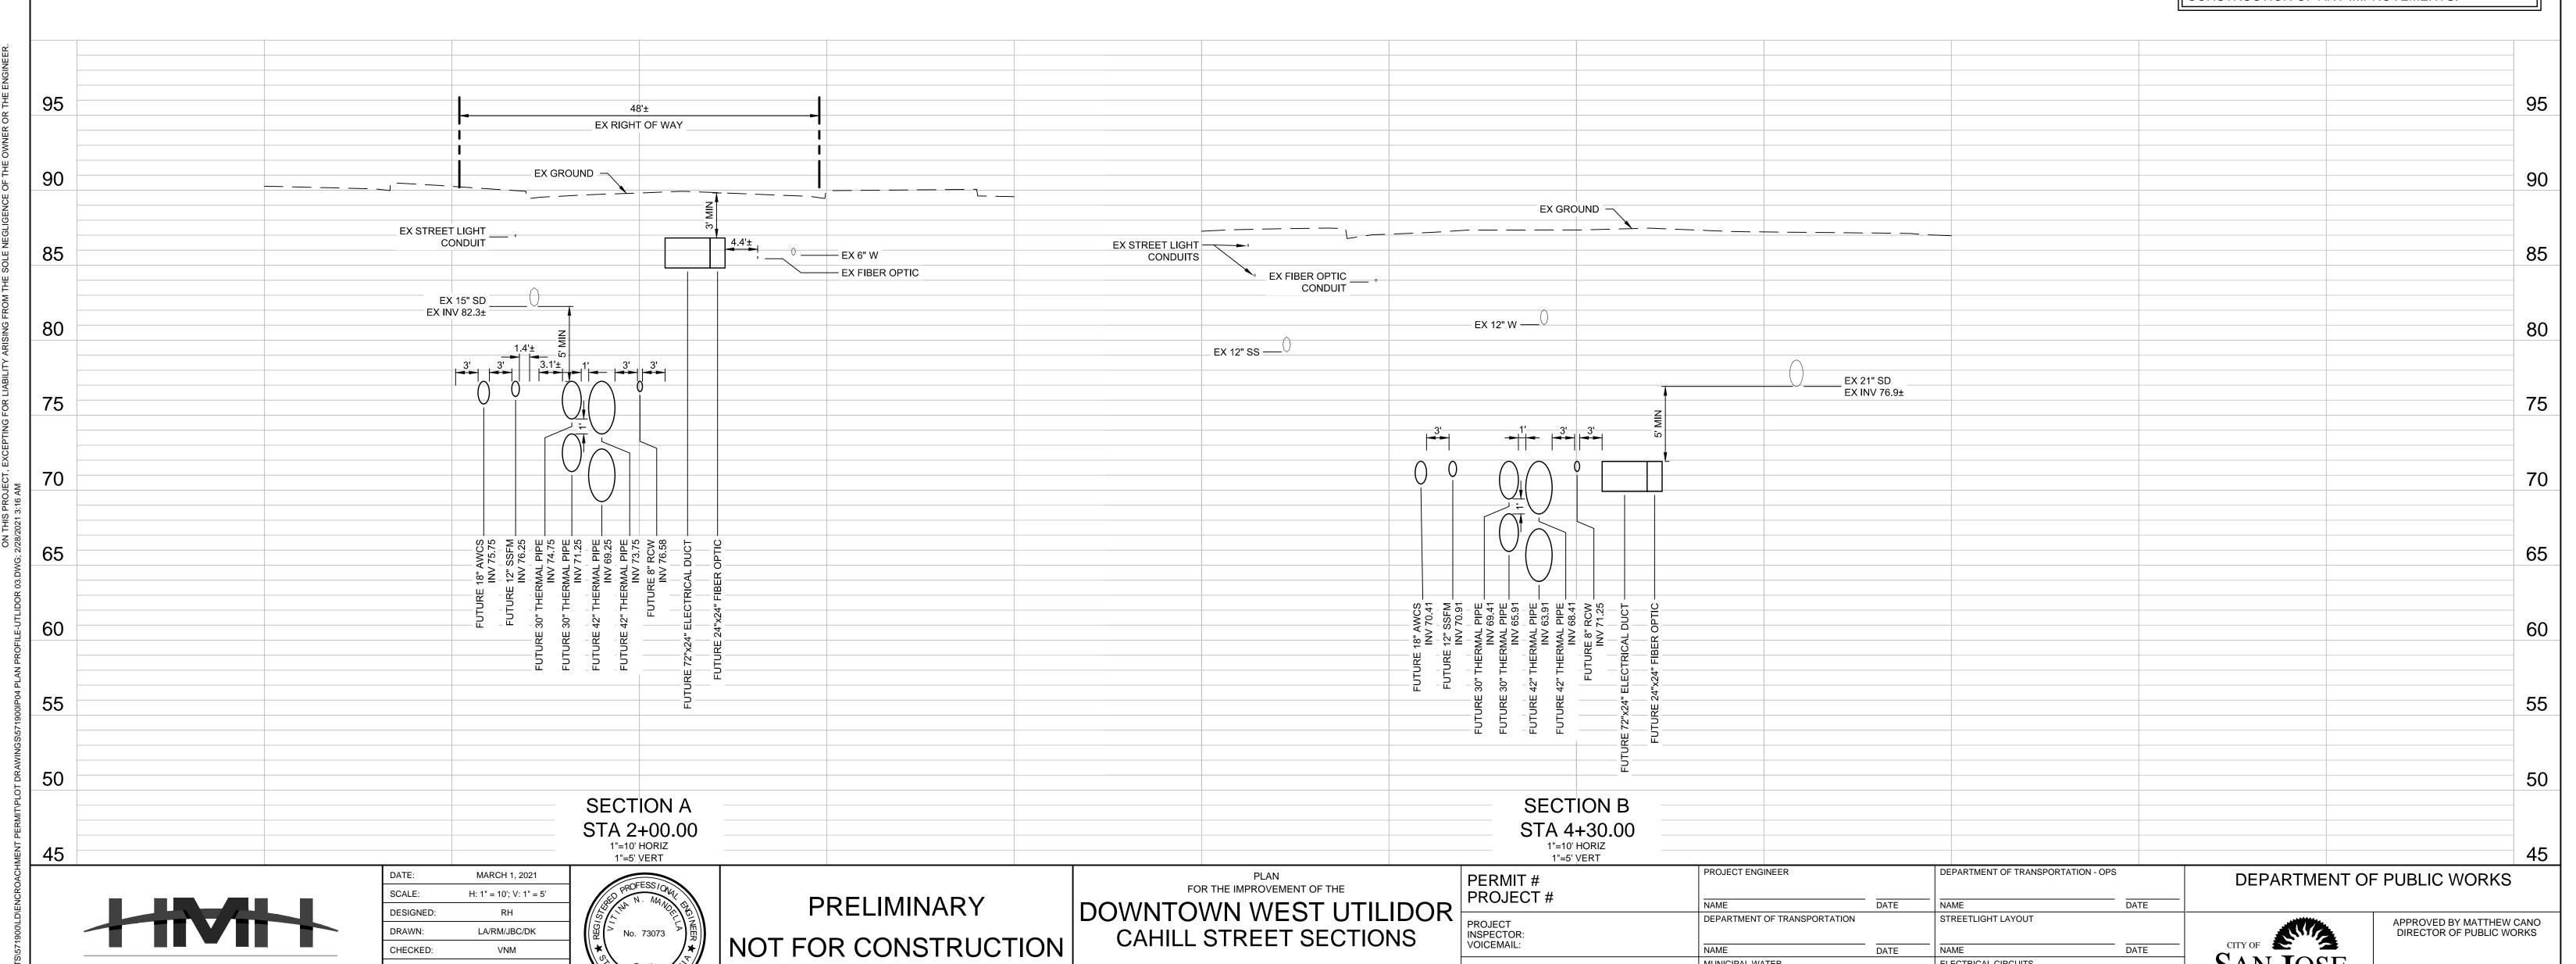

CALIFORNIA


SAN JOSE


1570 Oakland Road (408) 487-2200 San Jose, CA 95131 HMHca.com


PROJ. ENGR:


VNM

571900IP.DWG

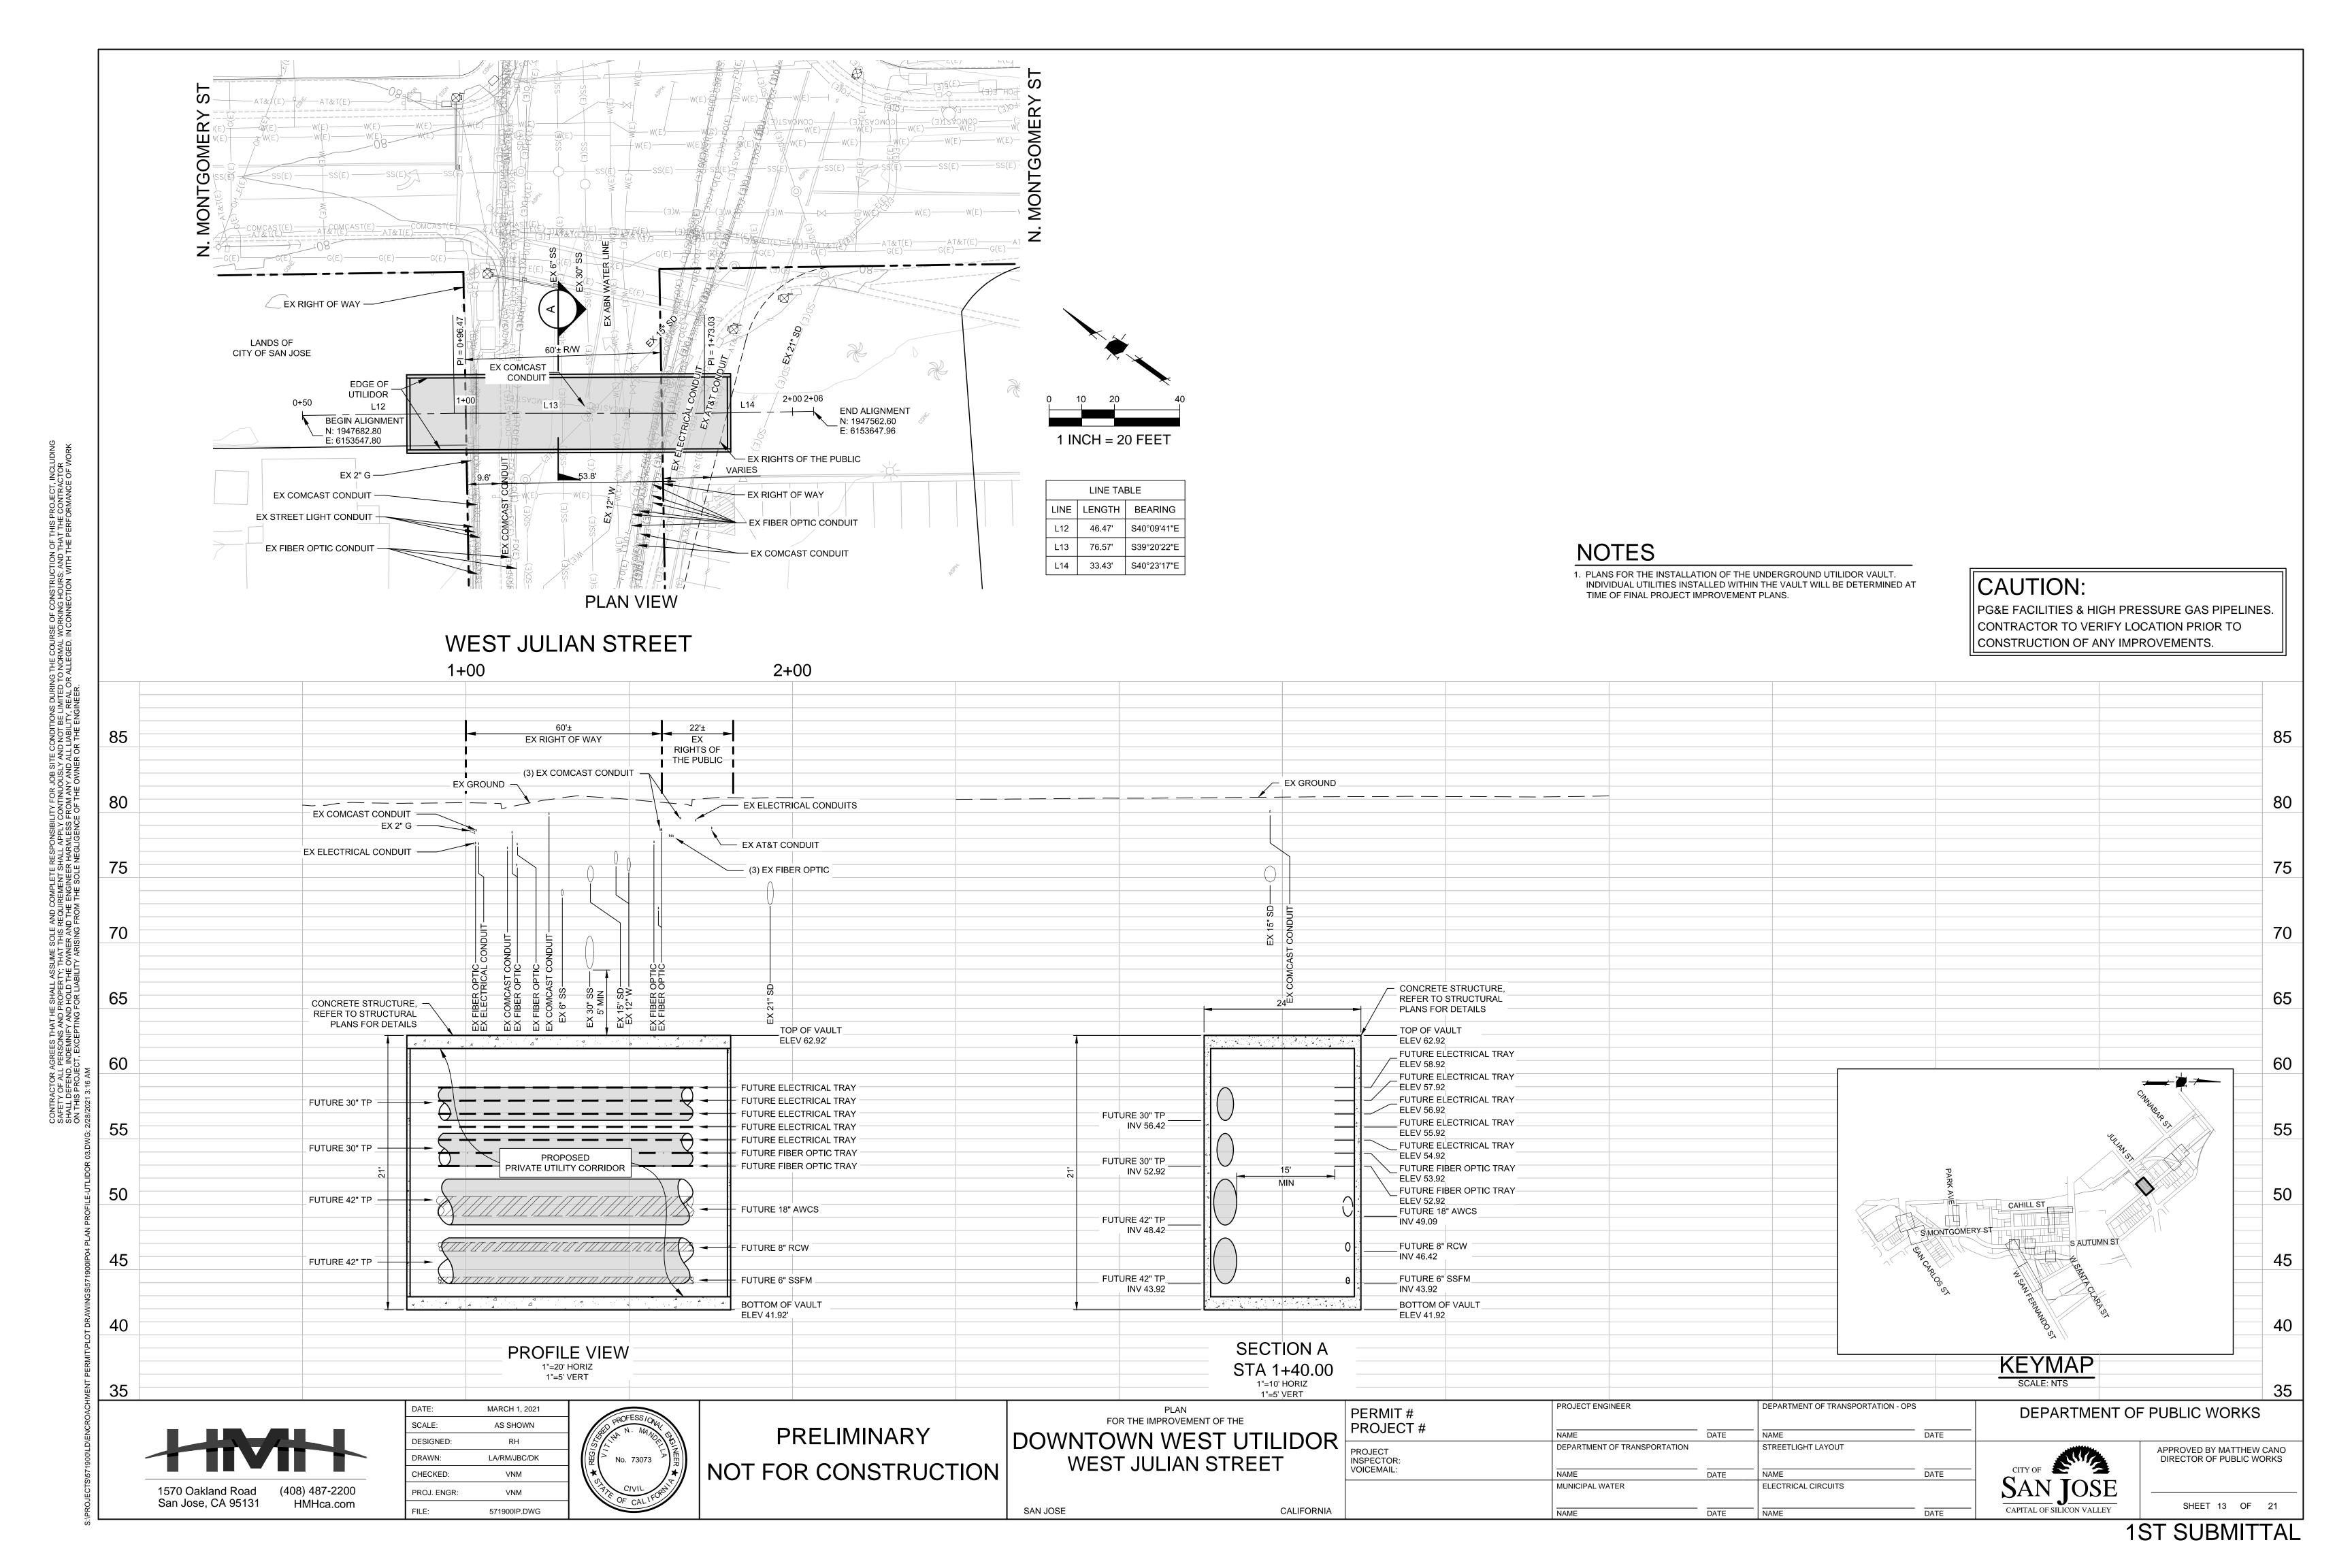

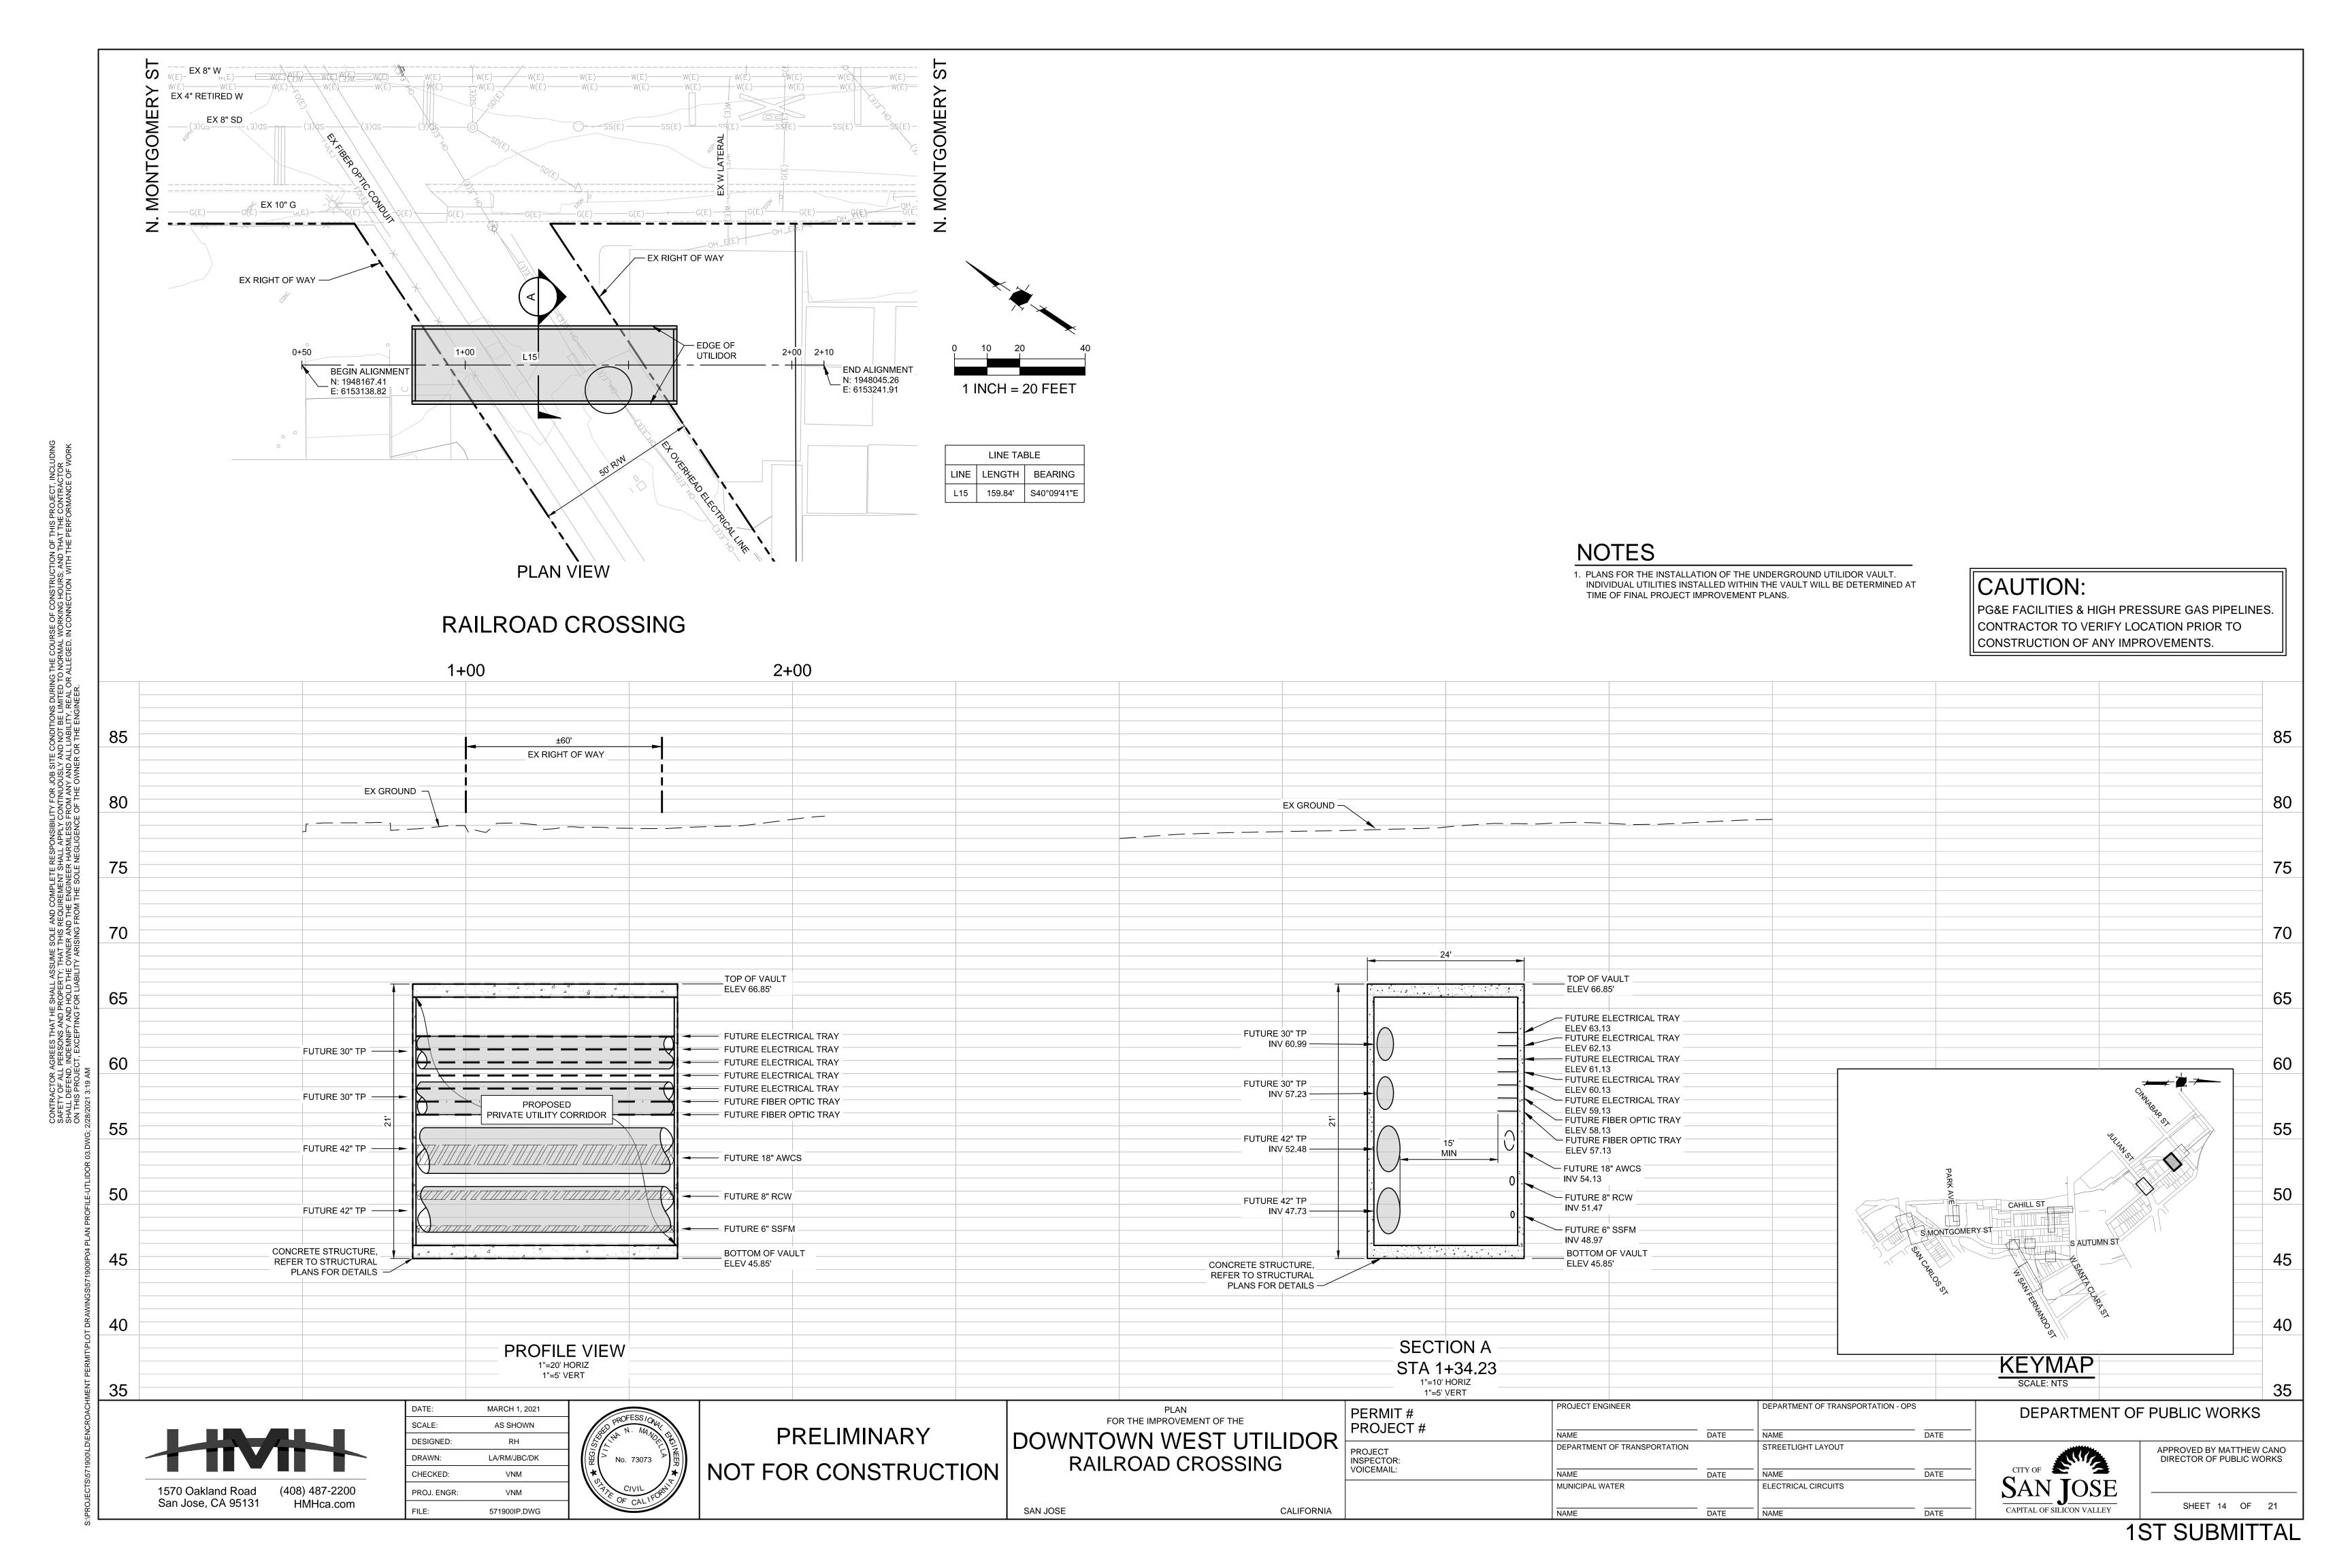

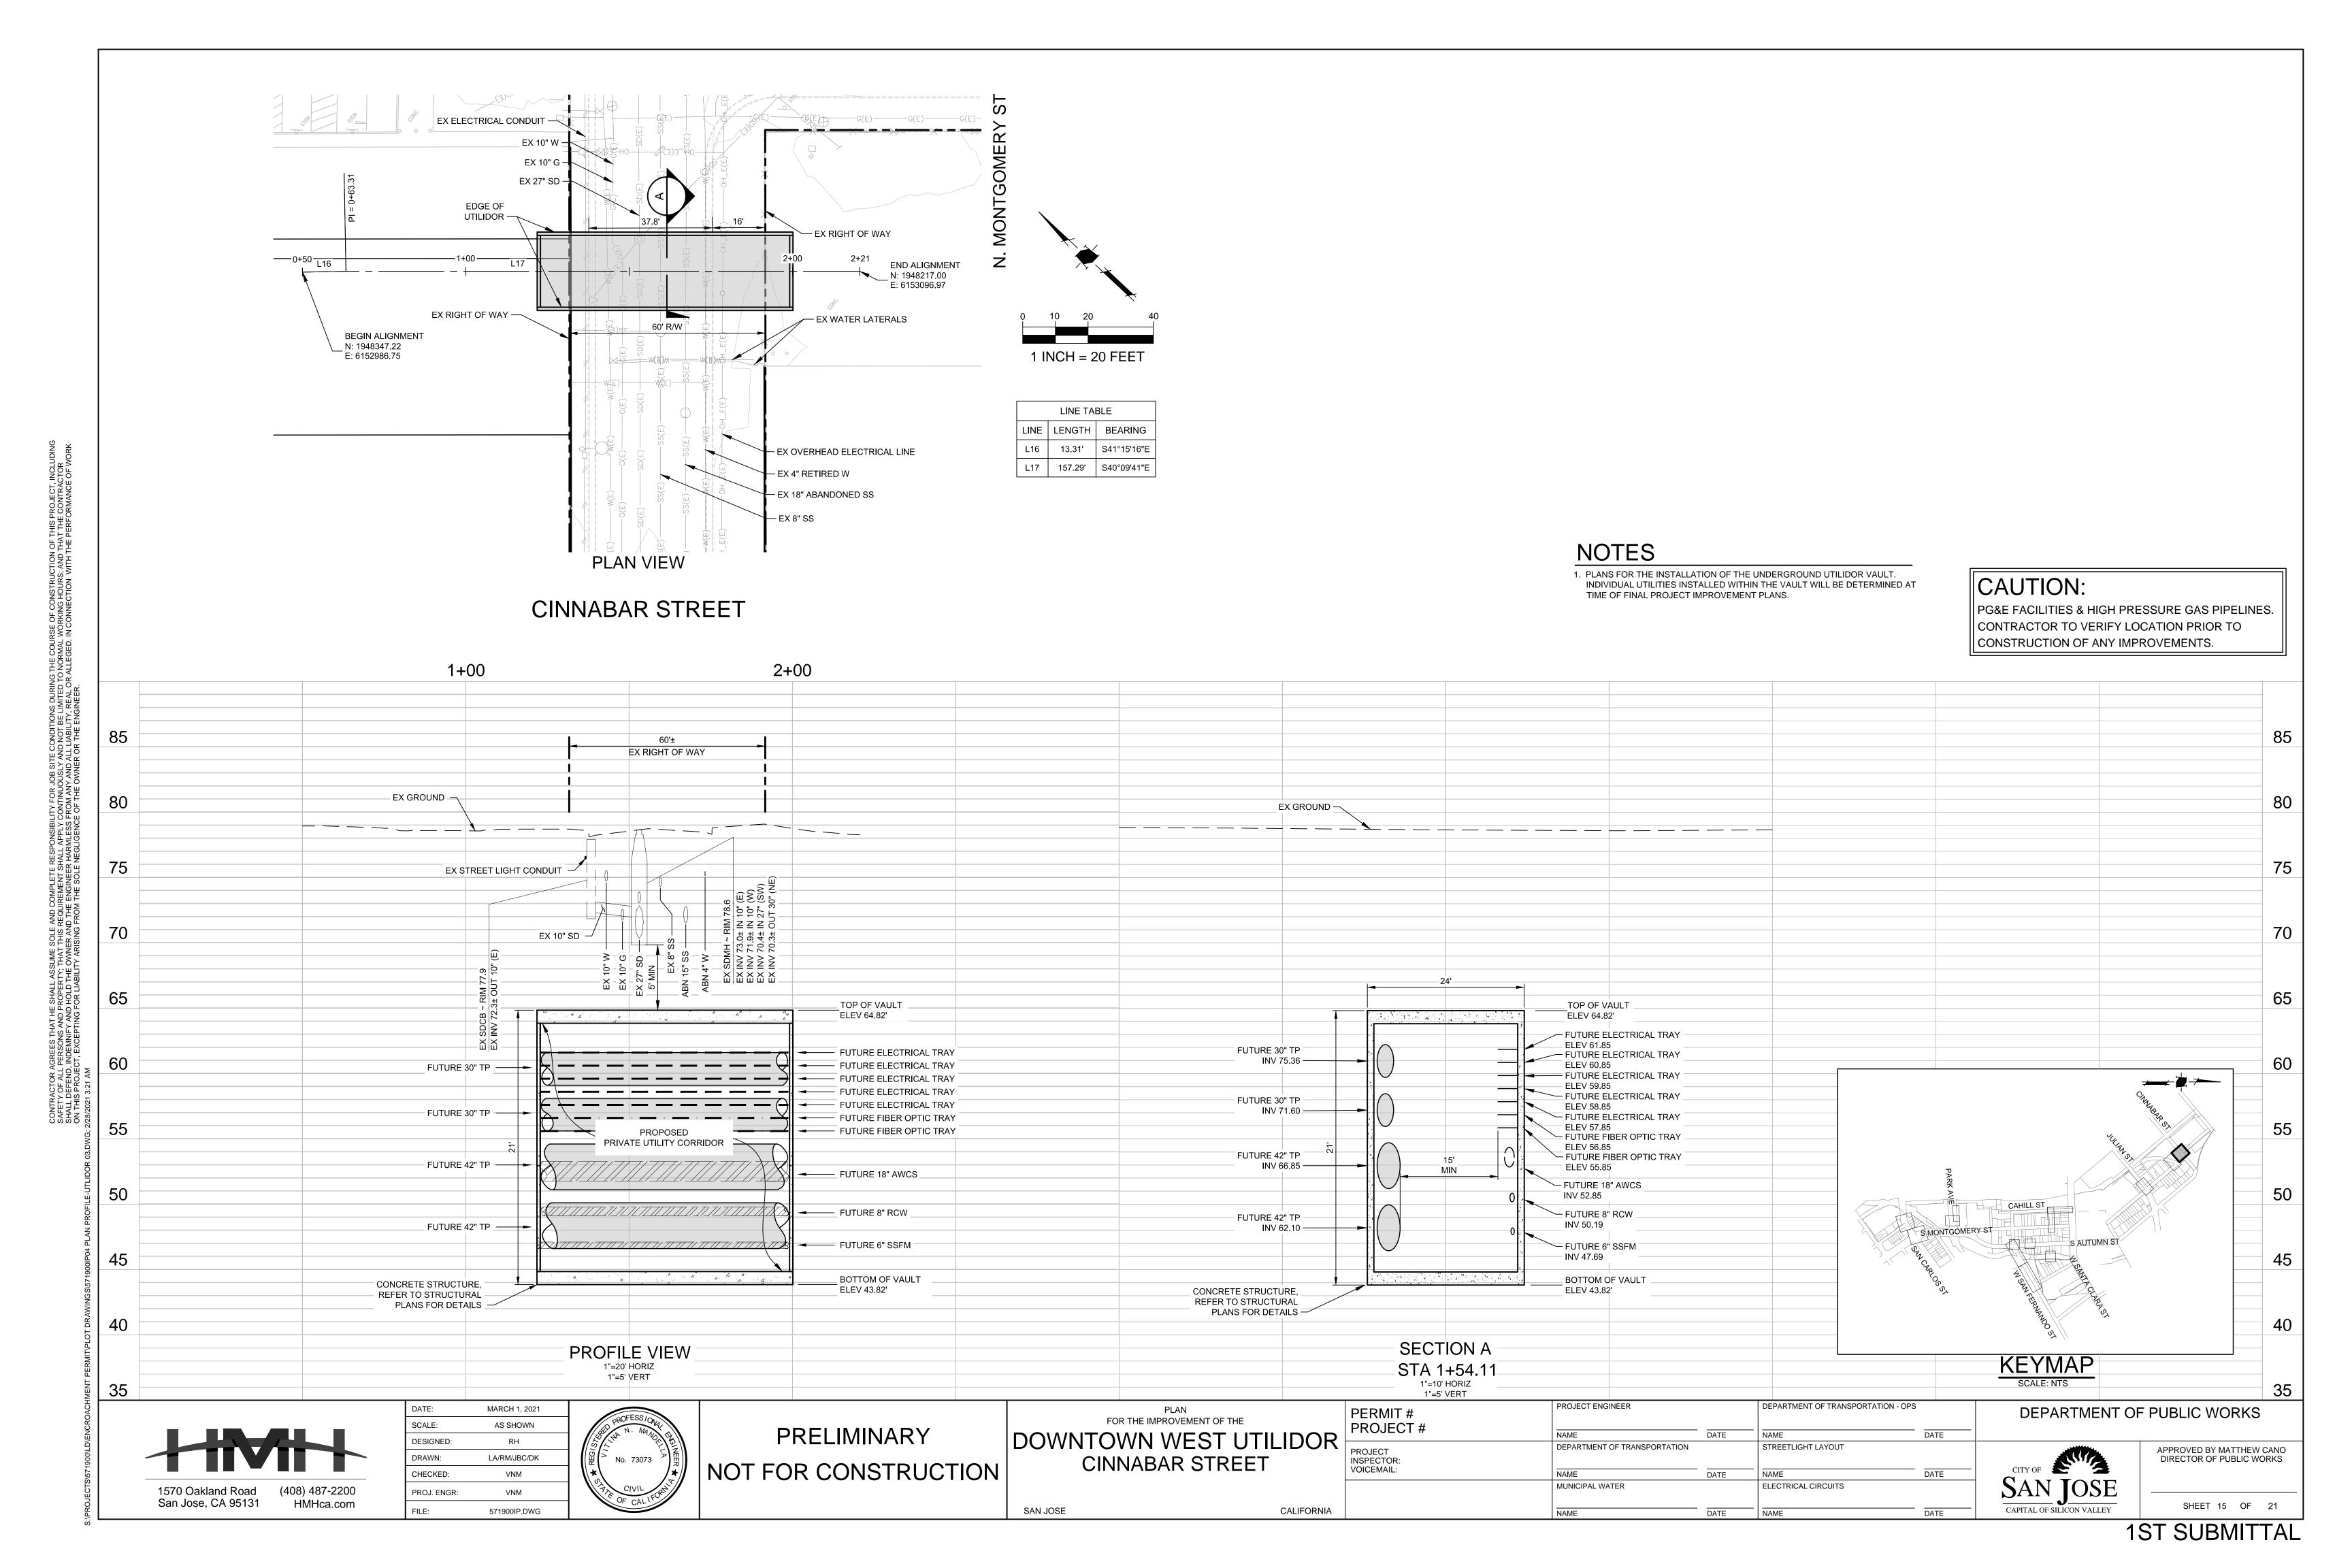

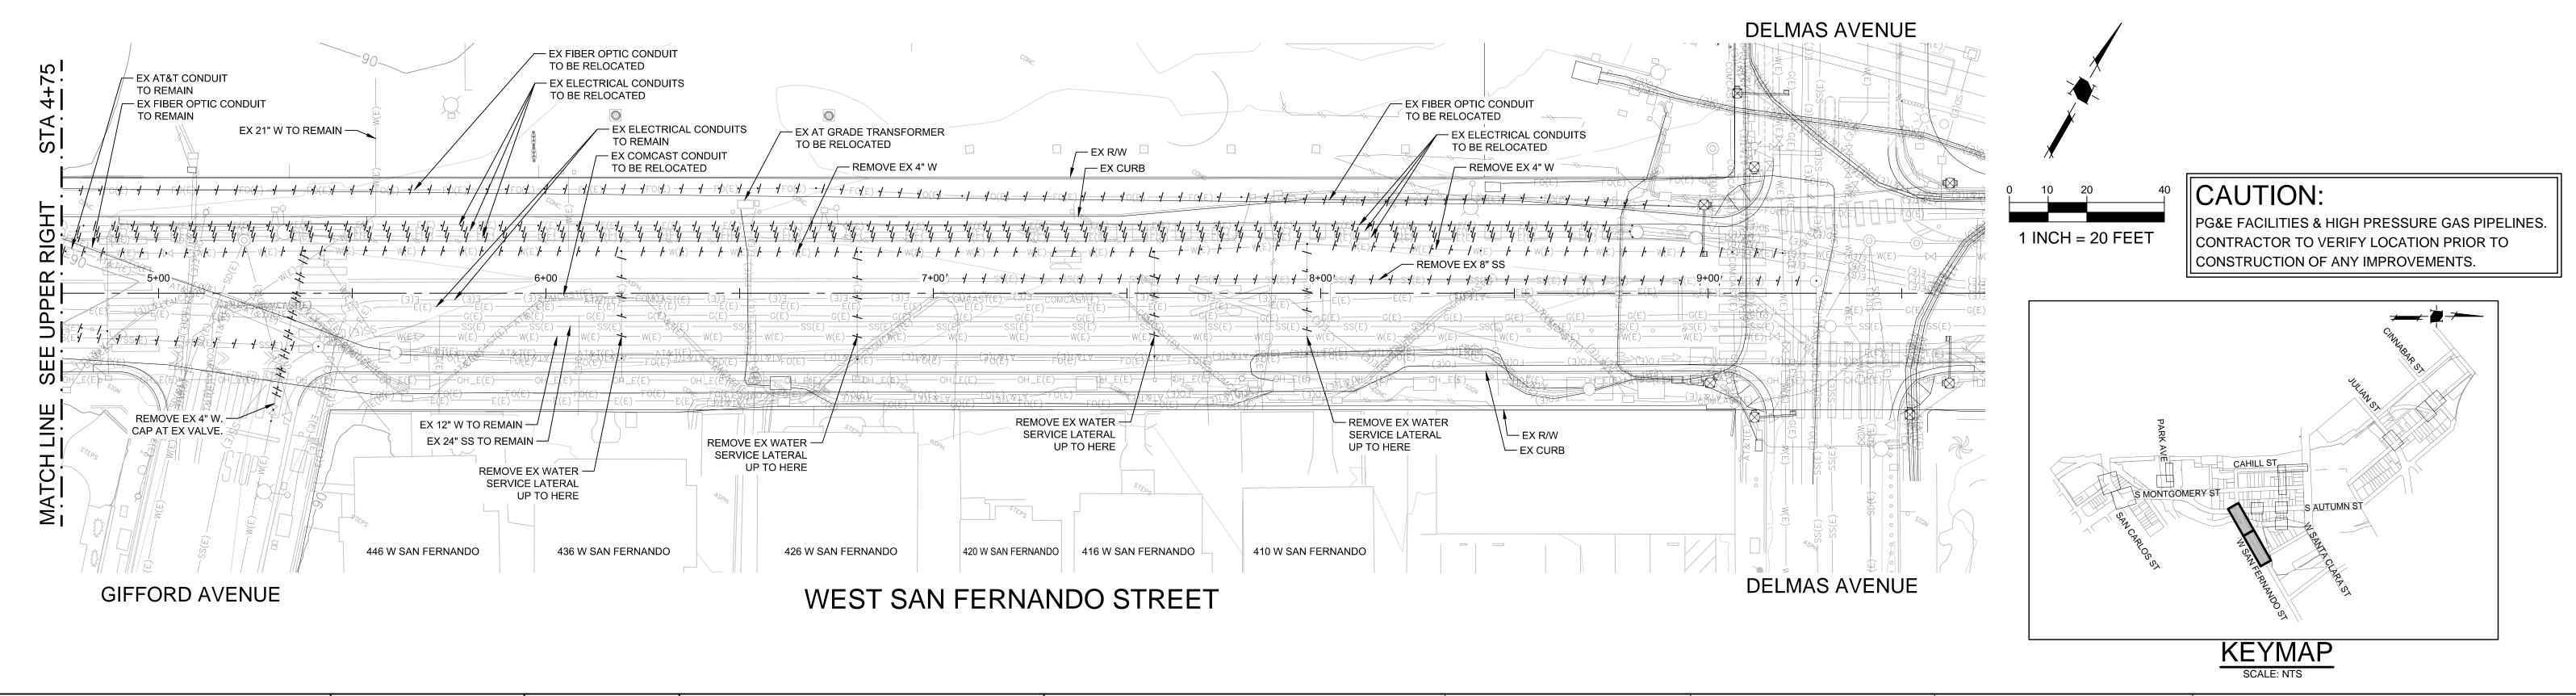



PROFESSIONAL REPORT OF CALIFORNIA PROFESSIONAL PROFESSIONA

MARCH 1, 2021

1" = 20'

RH

LA/RM/JBC/DK

VNM

VNM

571900IP.DWG

SCALE:

DESIGNED:

CHECKED:

PROJ. ENGR:

DRAWN:

PRELIMINARY
NOT FOR CONSTRUCTION

PLAN
FOR THE IMPROVEMENT OF THE

DOWNTOWN WEST UTILIDOR
DEMOLITION PLAN
WEST SAN FERNANDO STREET
SAN JOSE
CALIFORNIA

PROJECT # DEPARTMENT OF TRANSPORTATION - OPS

NAME

PROJECT INSPECTOR: VOICEMAIL:

DEPARTMENT OF TRANSPORTATION - OPS

DEPARTMENT OF TRANSPORTATION - OPS

NAME

DATE

DATE

NAME

DATE

NAME

DATE

NAME

DATE

STREETLIGHT LAYOUT

NAME

DATE

NAME

DATE

SAN JOSE


DATE


APPROVED BY MATTHEW CANO


DIRECTOR OF PUBLIC WORKS

DEPARTMENT OF PUBLIC WORKS

DATE

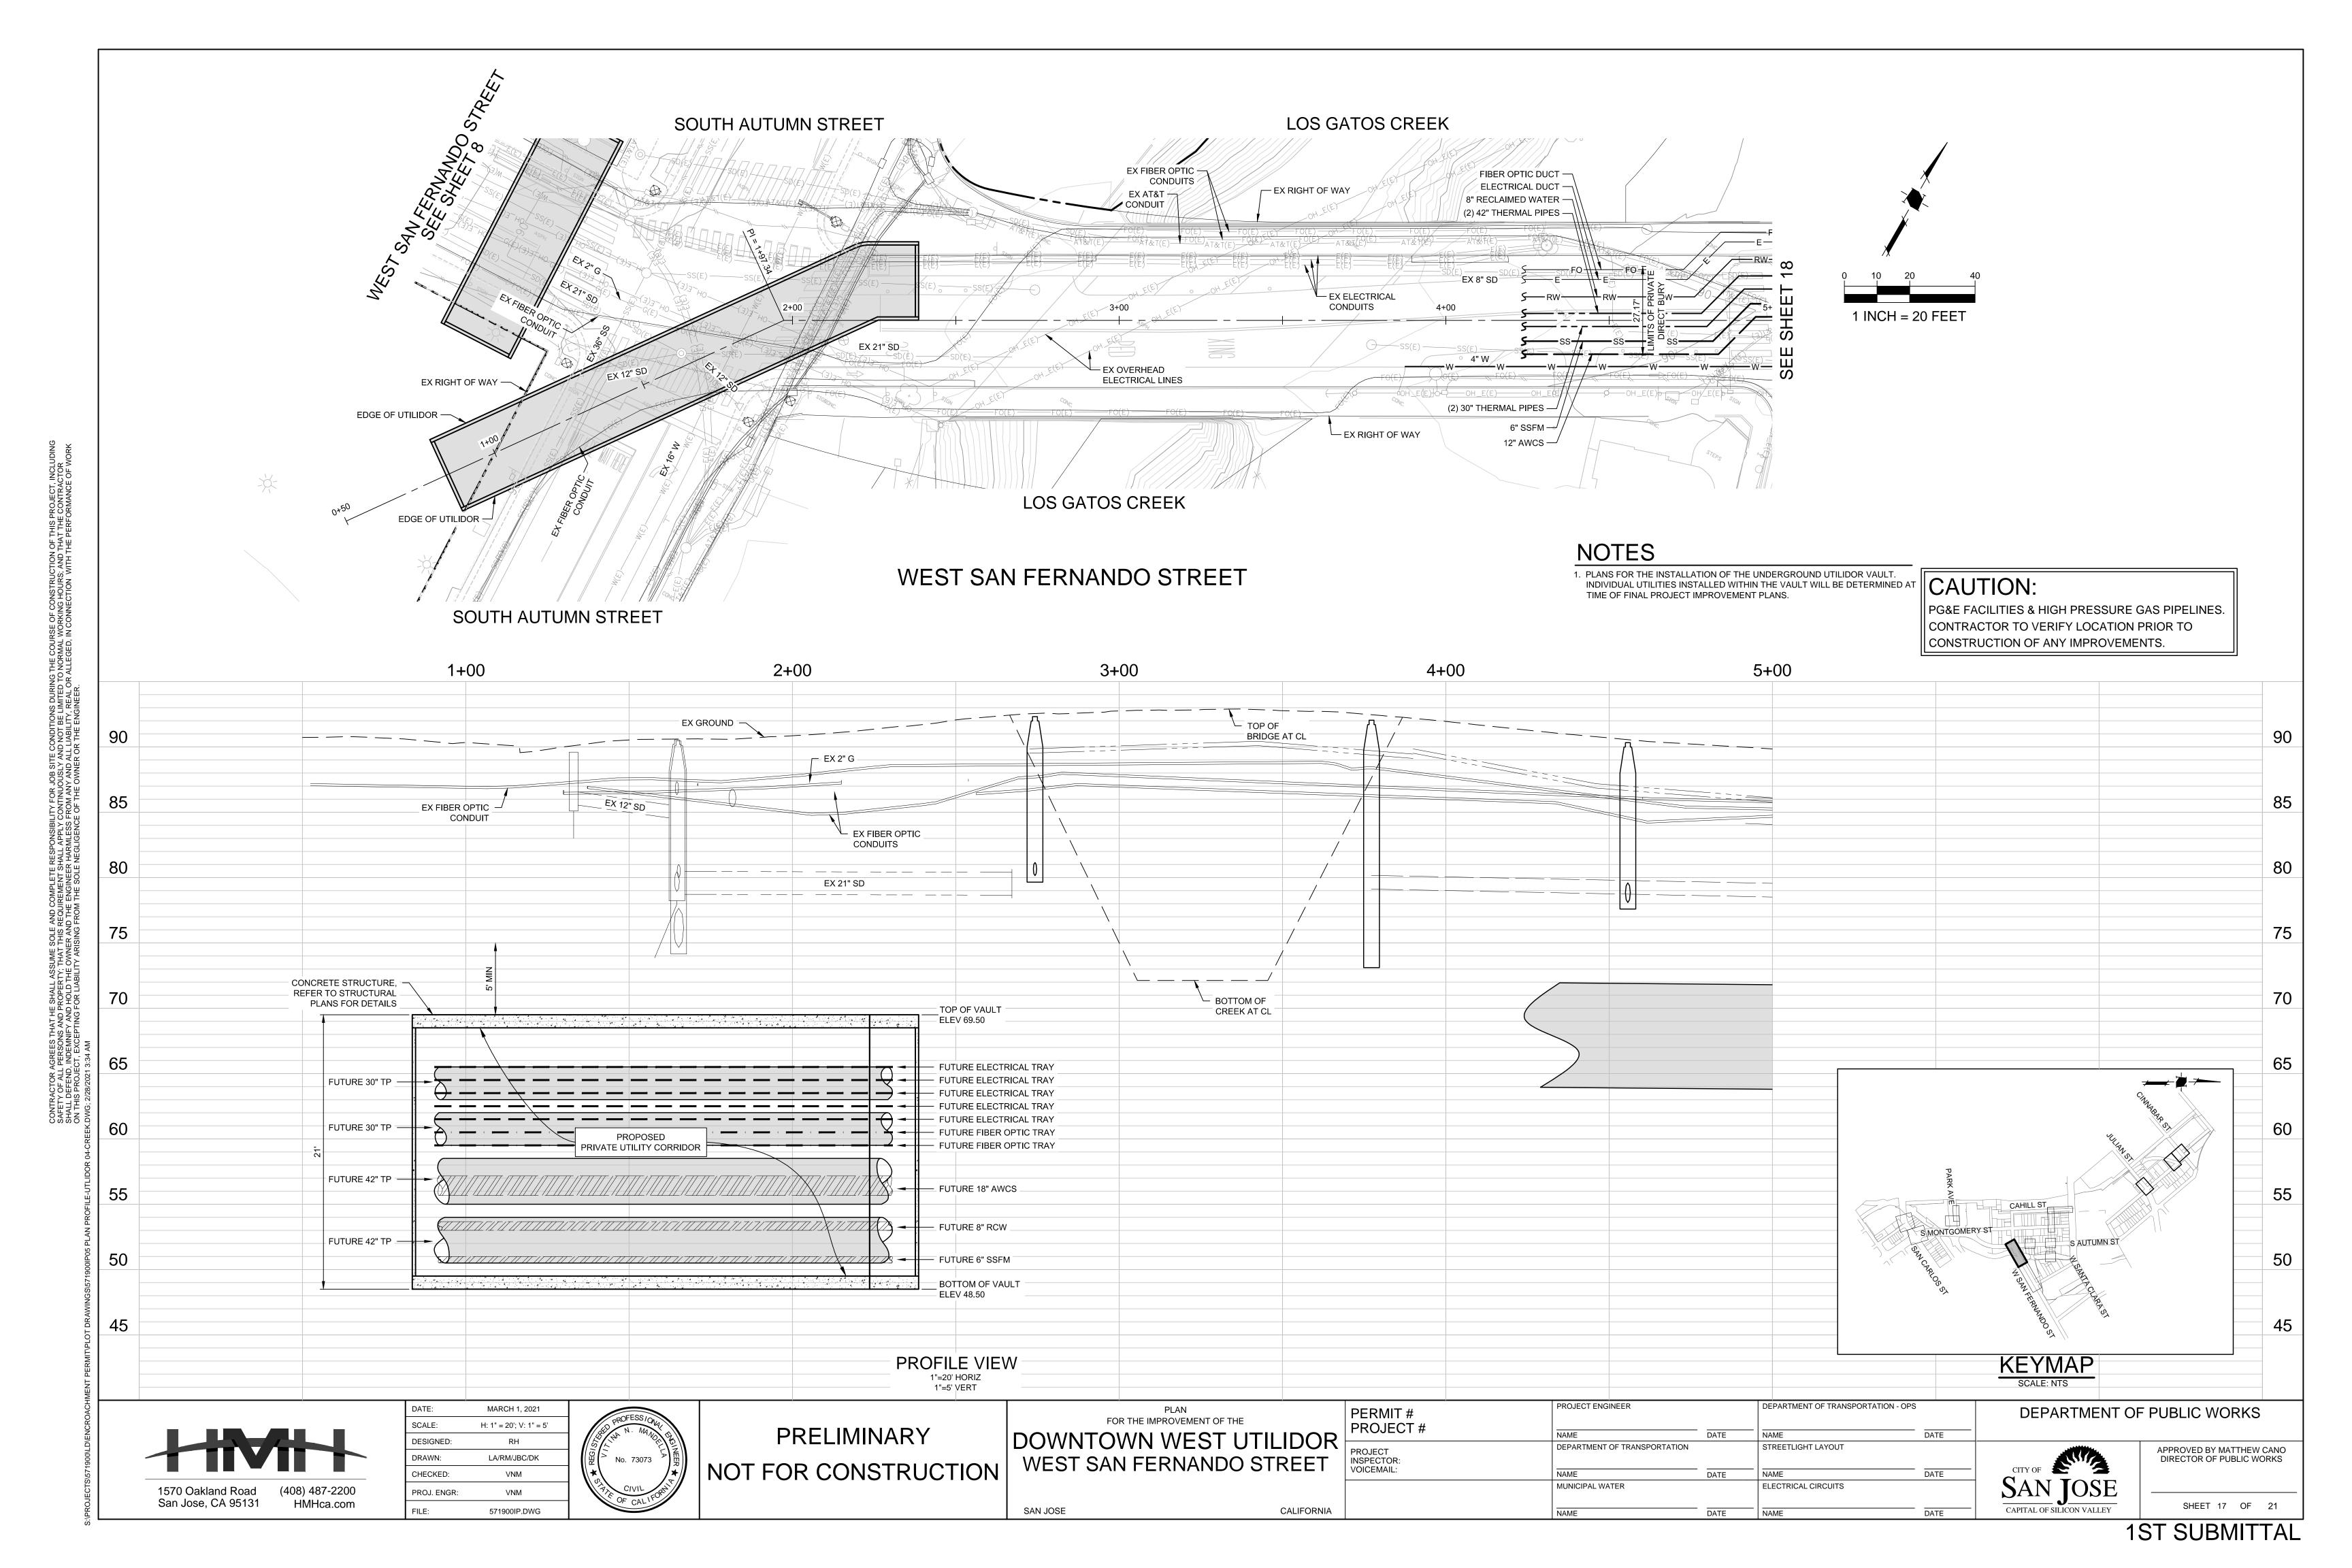

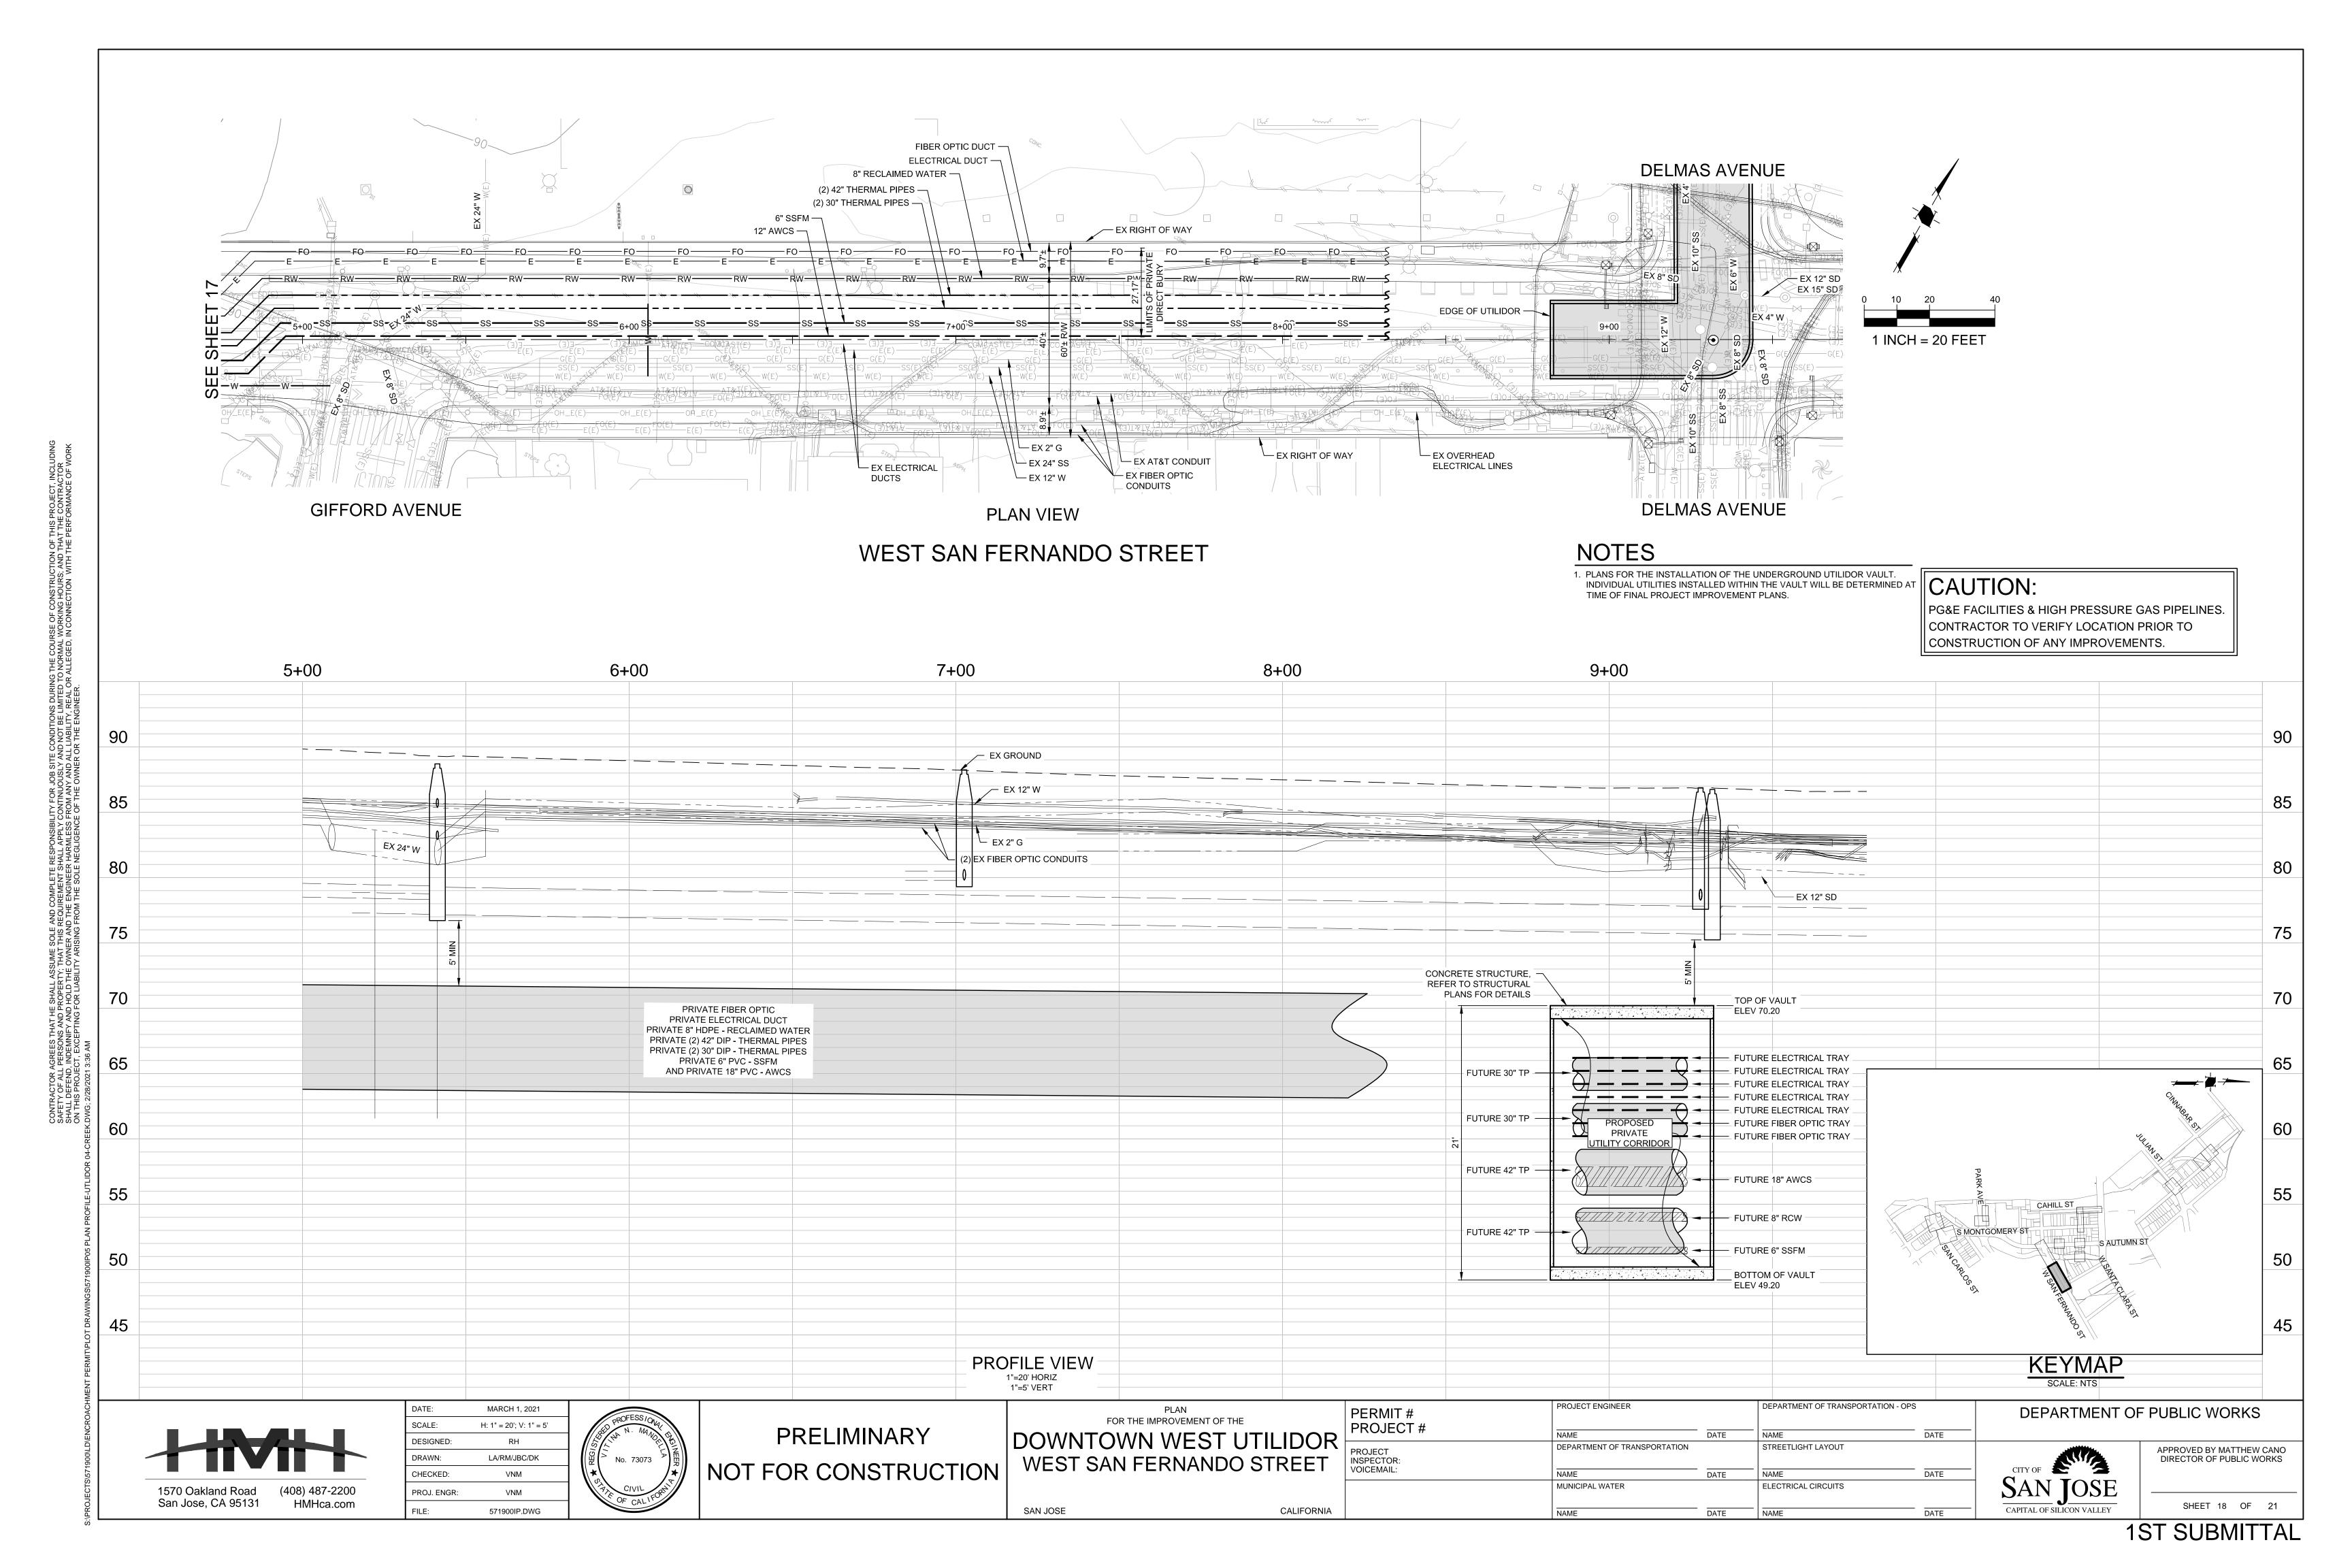

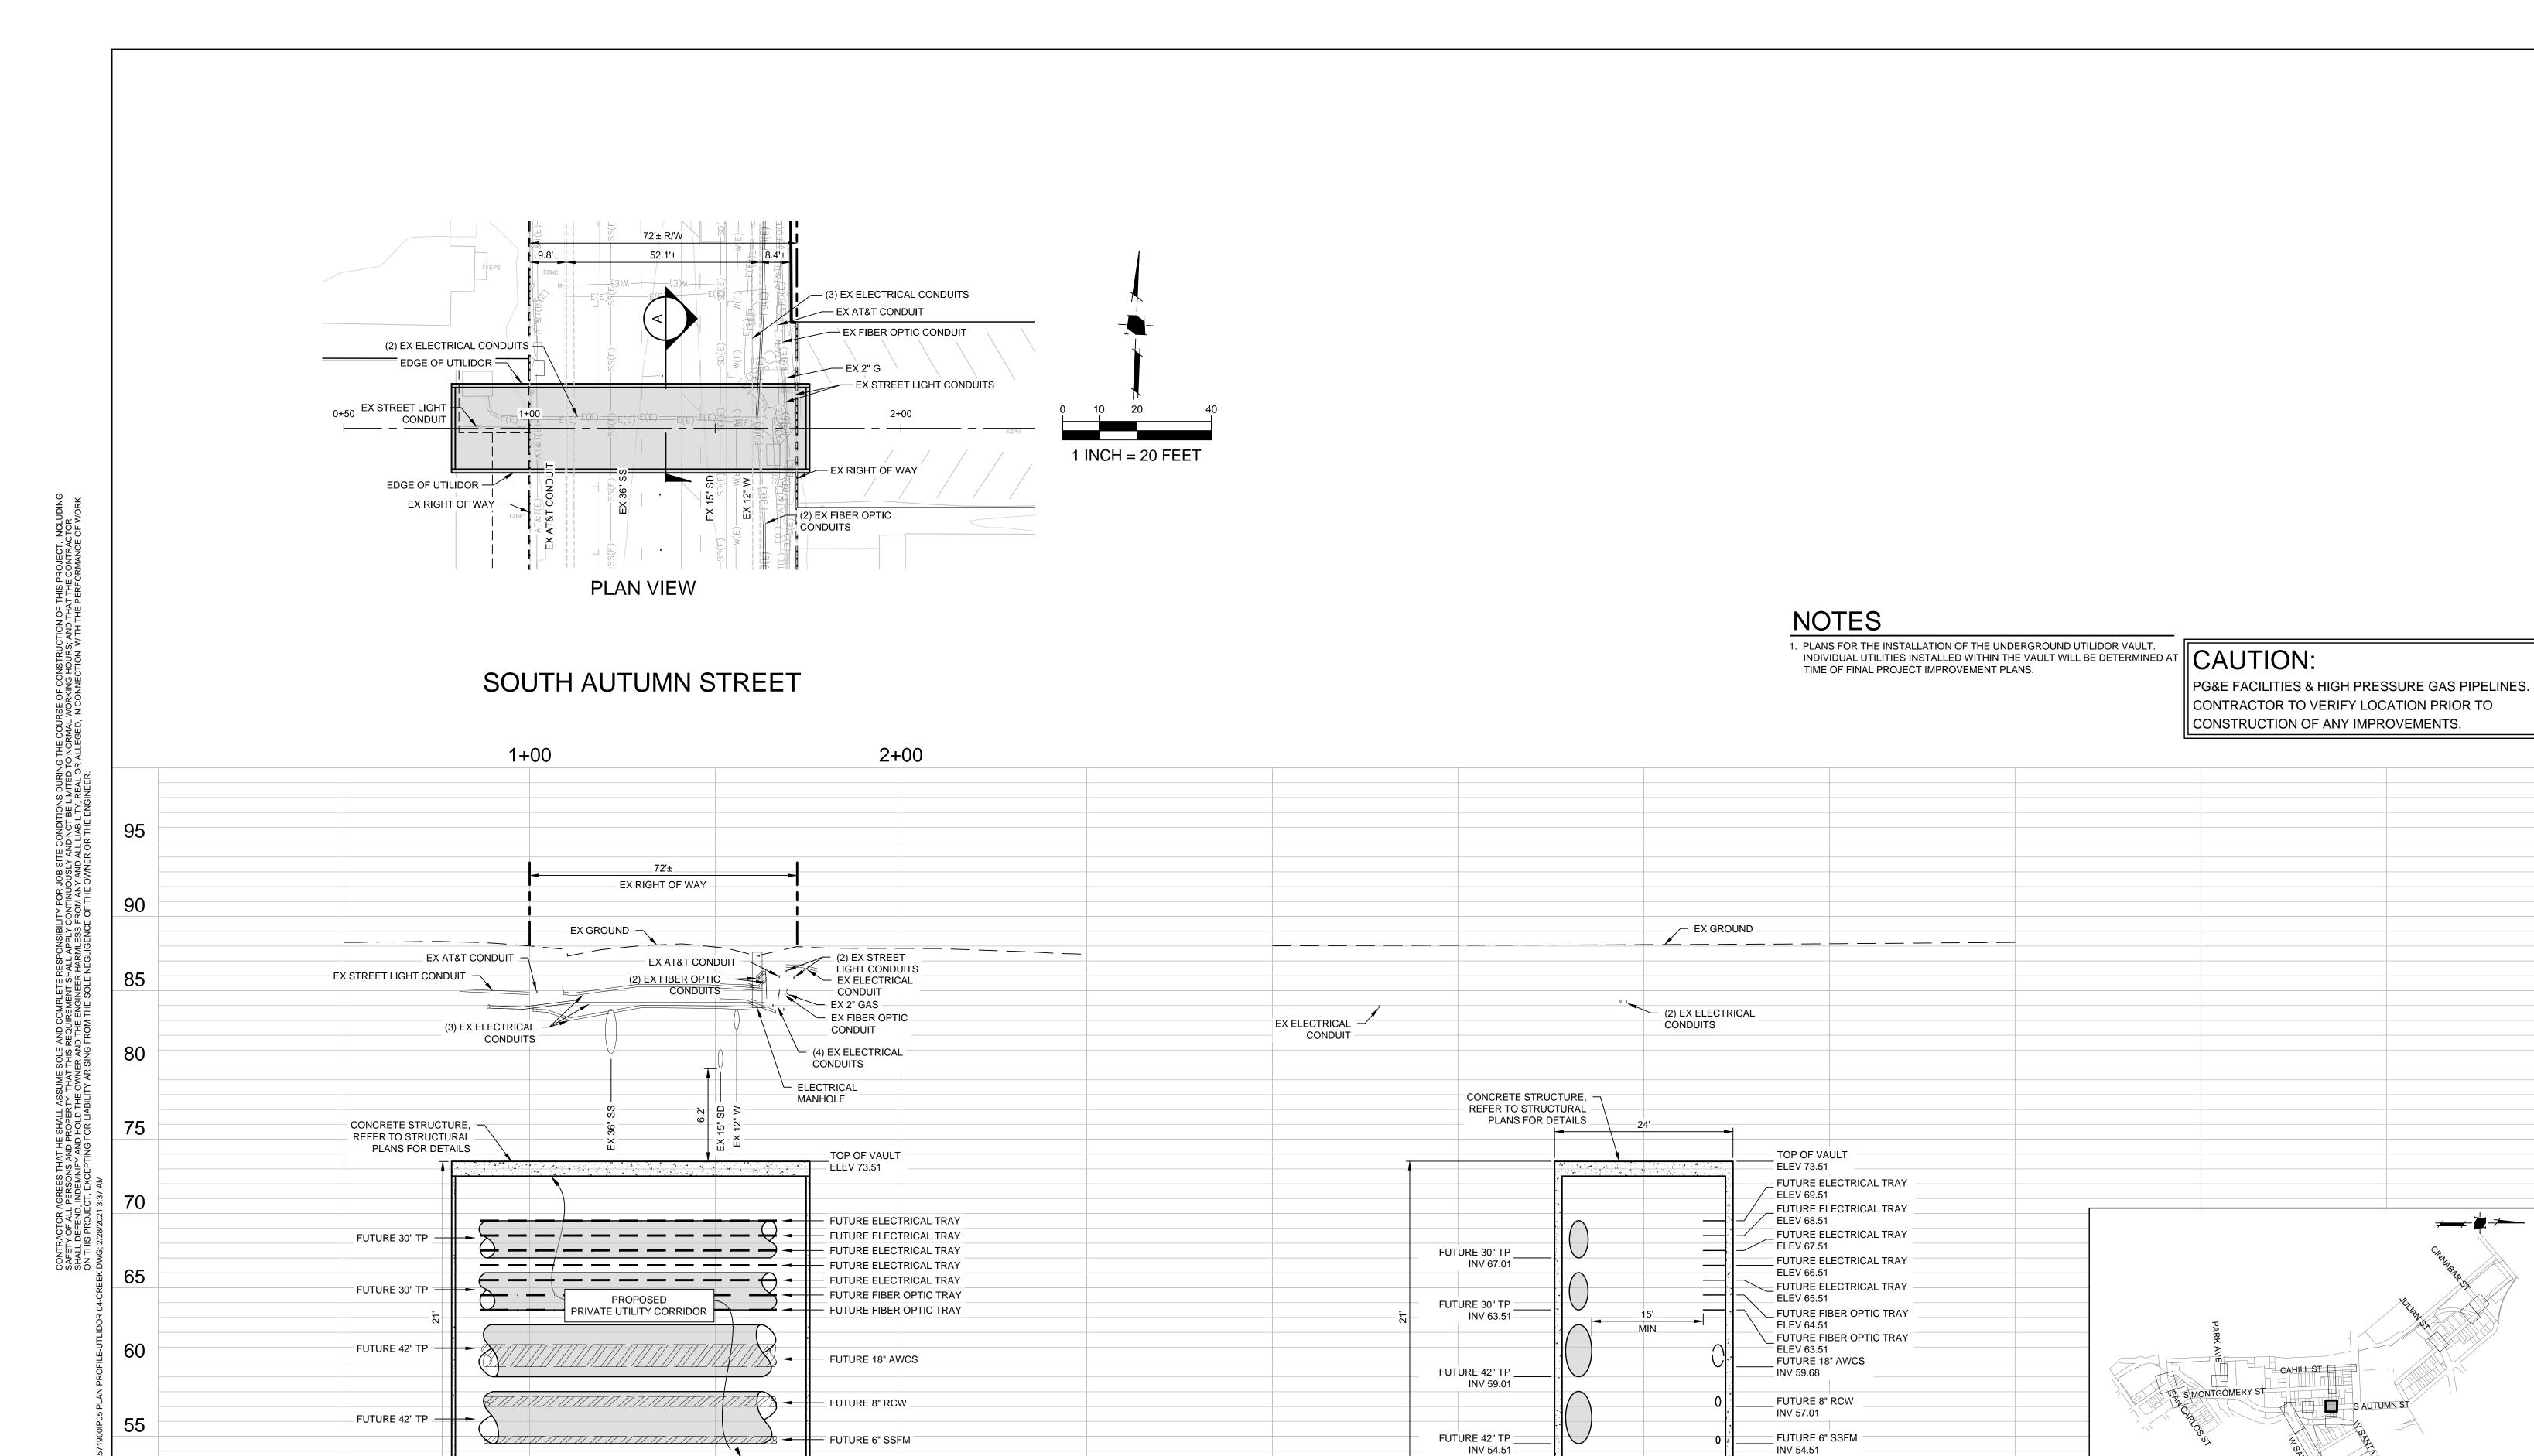

1570 Oakland Road San Jose, CA 95131 (408) 487-2200 HMHca.com

SCALE: AS SHOWN

DESIGNED: RH

DRAWN: LA/RM/JBC/DK

CHECKED: VNM

PROJ. ENGR: VNM

FILE: 571900IP.DWG

MARCH 1, 2021

PROFILE VIEW

1"=20' HORIZ

1"=5' VERT

PRELIMINARY

NOT FOR CONSTRUCTION

BOTTOM OF VAULT

PLAN
FOR THE IMPROVEMENT OF THE

DOWNTOWN WEST UTILIDOR
SOUTH AUTUMN STREET

CALIFORNIA

SAN JOSE

STA 1+36.01

1"=10' HORIZ
1"=5' VERT

PROJECT #

PROJECT | NAME

DATE

DATE

NAME

DATE

NAME

DATE

NAME

MUNICIPAL WATER

DATE

NAME

ELECTRICAL CIRCUITS

DATE

BOTTOM OF VAULT

ELEV 52.51

SECTION A

CITY OF SAN JOSE

CAPITAL OF SILICON VALLEY

DEPARTMENT OF PUBLIC WORKS

KEYMAP

DATE

DATE

APPROVED BY MATTHEW CANO DIRECTOR OF PUBLIC WORKS

SHEET 19 OF 21

85

80

75

70

55

50

